### PROJECT DESIGN TEAM

### OWNER

UNIVERSITY OF OREGON CONTACT: DAVID WARD PROJECT MANAGER FACILITIES SERVICES 1276 UNIVERSITY OF OREGON EUGENE, OR 97403-1276

## ARCHITECTURAL

2FORM ARCHITECTURE CONTACTS: RICHARD SHUGAR, AIA, AND SARAH DOOLEY 121 LAWRENCE STREET EUGENE, OR 97401 PHONE: 541,342,5777

#### FURNITURE

FNVIRONMENTS 707 SE BELMONT PORTLAND, OR 97214

PHONE: 541.346.2147

#### MECHANICAL

MOULDS MECHANICAL ENGINEERING P.O. BOX 22238, EUGENE OR, 97402 CONTACT: CHRIS MOULDS MECHANICAL ENGINEER PHONE: 541,484,0241

UNIVERSITY OF OREGON CONTACT: JOE DECARLO ZONE MAINTENANCE SUPERVISOR FACILITIES SERVICES PHONE: 541.346.8834

CONTACT: WILL FIGHEL BERGER PHONE: 503,963,6213 CELL: 971.645.0810

#### ELECTRICAL

PARADIGM ENGINEERING 85193 APPLETREE DRIVE. EUGENE OR, 97405 CONTACT: JIM KRUMSICK, P.E. ELECTRICAL ENGINEER PHONE: 541,285,1680

UNIVERSITY OF OREGON CONTACT: DENNIS YOSIKA ELECTRICAL SUPPORT MANAGER FACILITIES SERVICES PHONE: 541,346,1775

# Pol Bridge FRANKLIN BOULEVARD SCIENC C O M Jaqua SITE - Information (limited vehicle access University Carson

## VICINITY MAP



## PROJECT DESCRIPTION

### SCOPE OF WORK


- · SUMMARY: REMODEL OF EXISTING OFFICES, NO CHANGE IN USE OR OCCUPANCY.
- FRAMING: NEW INTERIOR PARTITION WALLS, NEW ACOUSTIC INSULATION TO BE INSTALLED IN EXPOSED EXISTING AND (N) CAVITIES
- FINISHES: NEW CARPET TILE, PAINT, TRIM/BASE
- FURNISHINGS: PARTIALLY (N) FURNITURE
- · CASEWORK: (N) KITCHEN CABINETRY
- · PLUMBING: (N) KITCHEN SINK
- ELECTRICAL/NETWORKING: NEW LIGHTING CONTROLS, DISTRIBUTION OF ELECTRICAL/DATA RUNS TO EACH WORKSTATION
- . HYAC: DUCT CLEANING, DUCTWORK REPLACEMENT AND FILTER REPLACEMENT

## ALTERNATES

- REPLACE CEILING GRID AND ACOUSTIC CEILING TILE (ACT) IN THE ENTIRE PROJECT AREA WITH ARMSTRONG ULTIMA WITH AIRGUARD COATING- #1903 24"X48" LAY-IN TILE WITH PRELUDE E" GRID, OR APPROVED EQUAL AND RE-USE (E) LIGHTING, SEE EIØ5 FOR ALTERNATE LIGHTING PLAN.
- DUCT CLEANING, DUCTWORK REPLACEMENT AND FILTER REPLACEMENT, SEE MIØ5 FOR SPECIFICATIONS.

#### CODE SUMMARY

- BUILDING CODE: 2010 OREGON STRUCTURAL SPECIALTY CODE
- OCCUPANCY GROUP "B" (BUSINESS GROUP, INCLUDES OFFICES AND EDUCATION ABOVE THE 12TH GRADE)
- OCCUPANCY SEPARATION: NONE REQUIRED
- CONSTRUCTION TYPE: III-A (ONE HOUR)
- FIRE PROTECTION: SPRINKLERED: FIRE ALARM SYSTEM TO MEET REQUIREMENTS OF NFPAT2, WHERE REQUIRED.

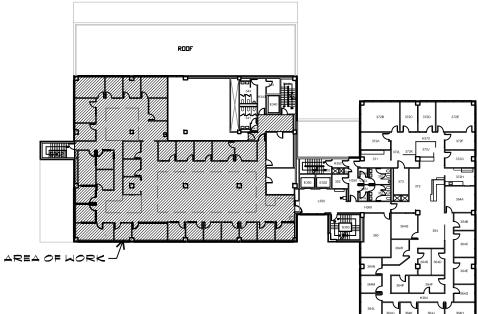

## KEY PLAN

EINIGH EL OOD DI AN

SCALE: 1" = 50'0'


#### SITE INFORMATION

ADDRESS: UNIVERSITY OF OREGON, 1585 EAST 13TH EUGENE, OREGON 97403-1278

- PROJECT AREA: 7,272 SQUARE FEET
- THIRD FLOOR AREA: 18,380 SQUARE FEET

## GENERAL NOTES

- I. COMPLY WITH ALL CODES, ORDINANCES, AND GOVERNMENT AGENCIES.
- 2. ALL CONSTRUCTION IS TO COMPLY WITH THE 2010 OREGON STRUCTURAL SPECIALTY CODE, AS AMENDED BY THE STATE OF OREGON.
- 3. DIMENSIONS ARE TO FACE OF FINISH OR CASEWORK. LINI ESS NOTED OTHERWISE
- 4. VERIFY AND COORDINATE WITH PLUMBING, MECHANICAL, AND ELECTRICAL.
- 5. DO NOT SCALE DRAWINGS. CONTRACTOR SHALL RELY ON WRITTEN DIMENSIONS AS GIVEN. THE CONTRACTOR SHALL NOTIFY THE ARCHITECT FOR CLARIFICATIONS. ALL DIMENSIONS SHALL BE FIELD VERIFIED BY CONTRACTOR & COORDINATED W/ THE WORK OR TRADES. IF DISCREPANCIES ARE FOUND, THE CONTRACTOR SHALL NOTIFY THE ARCHITECT BEFORE THE COMMENCEMENT OR RESUMPTION OF WORK.
- IF THE CONTRACTOR DISCOVERS AT ANY TIME THAT 6. REQUIREMENTS OF THIS CONTRACT CONFLICT W/ OR ARE IN VIOLATION OF APPLICABLE LAWS, CODES, REGULATIONS & ORDINANCES, HE SHALL NOT PROCEED W/ WORK IN QUESTION UNTIL ARCHITECT HAS BEEN NOTIFIED IN WRITING & WRITTEN DETERMINATION IS MADE BY THE ARCHITECT, WHERE COMPLETED OR PARTIALLY COMPLETED WORK IS FOUND TO BE IN VIOLATION W/ APPLICABLE LAWS, CODES, REGULATIONS OR ORDINANCES, CONTRACTOR SHALL BE REQUIRED TO REMOVE THAT WORK FROM THE PROJECT & REPLACE SUCH WORK W/ ALL NEW COMPLYING WORK AT NO ADDITIONAL COST TO THE OWNER OR ARCHITECT.
- 7. CONTRACTOR SHALL PROVIDE & INSTALL STIFFENERS, BRACING, BACK-UP PLATES & SUPPORTING BRACKETS REQUIRED FOR THE INSTALLATION OF FLOOR-MOUNTED OR SUSPENDED MECHANICAL & ELECTRICAL EQUIPMENT.
- 8. CONTRACTOR SHALL VERIFY THE LOCATIONS OF EXISTING UTILITIES BELOW FLOOR LEVEL & RELATED SERVICE CONNECTIONS W/ THE RESPECTIVE UTILITY COMPANIES.
- 9. SHOP DRAWINGS SHALL BE SUBMITTED FOR EQUIPMENT & MATERIALS WHICH MUST INTERFACE & COORDINATE W/ OTHERS, WHETHER DETAILED OR NOT.
- 10. PATCH AND REPAIR STRUCTURE, FRAMING, AND FINISHES AFFECTED BY CONSTRUCTION.
- ALL UNFINISHED FACES AND EDGES, WHETHER EXPOSED  $\overline{\hspace{1cm}}$  OR NOT, OF ALL CASEWORK, COUNTERTOPS, SHELVING, SYSTEMS FURNITURE, ETC. SHALL BE SEALED WITH SAFECOAT SAFE SEAL PARTICLE BOARD AND PLYWOOD SEALER.
- 12. ALL PROJECT SIGNAGE TO BE OFOI.
- 13. MODIFICATION OF EXISTING FIRE ALARM SYSTEM IN REMODELED SPACE TO BE PROVIDED BY SEPARATE FIRE ALARM CONTRACTOR UNDER SEPARATE CONTRACT WITH OWNER.

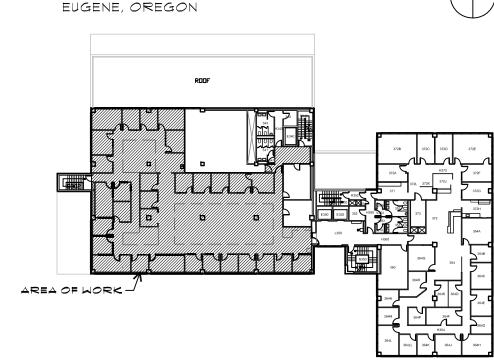

### DRAWING INDEX

ARCHITECTURAL

	<del></del>	4123	FINISH FLOOR ISLAN
G001	COVER, GENERAL NOTES, INDEX,	A1Ø4	FURNITURE PLAN
	MAPS, & KEY PLAN	A1Ø5	TYP, CEILING BRACING
G002	CODE SUMMARY	A4Ø1	INTERIOR ELEVATIONS
G003	ABBREVIATIONS	A4Ø2	INTERIOR ELEVATIONS
DIØ1	DEMO PLAN	A5Ø1	DOOR AND WINDOW DETAILS
A1Ø1	FLOOR PLAN	A6Ø1	DOOR AND WINDOW SCHEDULES
A1Ø2	REFLECTED CEILING PLAN	A6Ø2	ALL-IN-ONE & FINISH SCHEDULES

## ELECTRICAL

EØØ1 COVER, GENERAL NOTES, INDEX, MAPS, & KEY PLAN ELECTRICAL DEMO PLAN E101 LIGHTING DEMO PLAN F102 PROPOSED ELECTRICAL PLAN E103 PROPOSED LIGHTING PLAN: BASE BID E1Ø4 E1Ø5 PROPOSED LIGHTING PLAN: ALTERNATE BID PARTIAL ELECTRICAL ONE LINE DIAGRAM F106 EIØ7 ELECTRICAL SCHEDULES

NORT

## MECHANICAL SET

MØØ1 HYAC LEGEND HYAC PLAN DEMO - BASE BID M1Ø1 M1Ø2 HYAC PLAN - BASE BID HVAC PLAN DEMO - ALT. #1 M1Ø3 M1Ø4 HYAC PLAN - ALT. #1 M1Ø5 DUCT CLEANING M106 PLUMBING PLAN



121 Lawrence St. Eugene OR 97401 p. 541.342.5777 f. 541.342.6128 www.2-form.com



 $\square$ Щ OREGON 8  $\overline{\mathbf{c}}$ OF ₹ H 200 00 S

2


ΛE

REVISIONS DATE REFERENCE

ROJECT N 13006 DATE 05 AUGUST 201.


DRAWING TITLE TITLE SHEET

DRAWING NUMBER

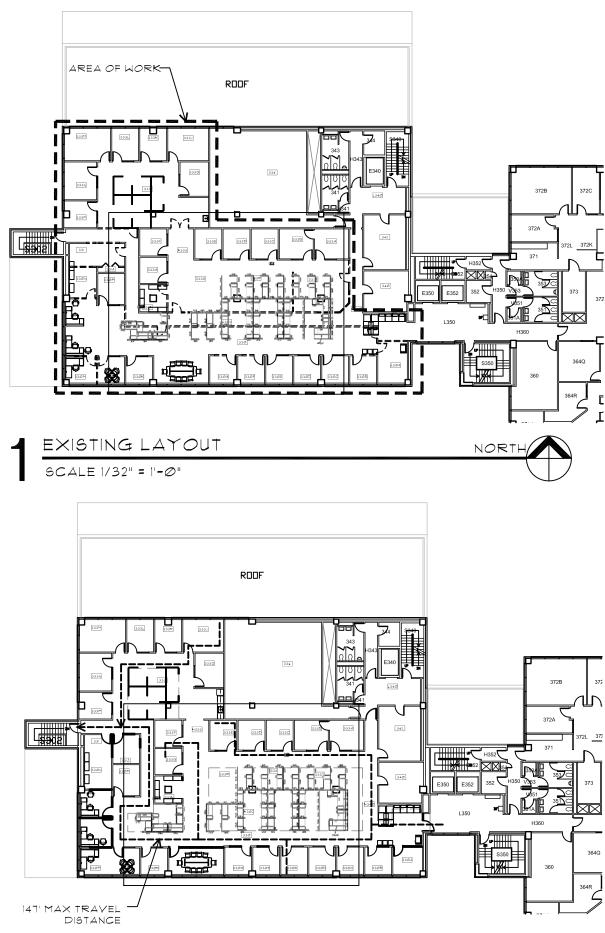

S EXITING DIAGRAM

9CALE 1/16" = 1'-0"

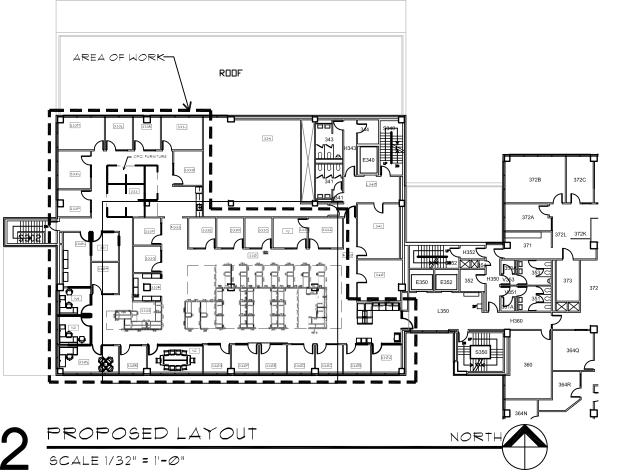


## EXITING NOTES:

NO CHANGE IN OCCUPANCY LOAD OR EGRESS CONDITIONS EXISTING BUILDING INFORMATION

- AREA PER FLOOR: AVERAGE 18,400 SQUARE FEET
  - OCCUPANCY LOAD FACTOR: 100 GROSS
  - MINIMUM DESIGN OCCUPANCY: 184 OCCUPANTS
  - MIN. CORRIDOR WIDTH =  $184 \times 0.2 = 37$ "
  - EXISTING CORRIDOR EXIT 51" AT NARROWEST POINT - I HOUR SEPARATION TO BE MAINTAINED

## EXIT ACCESS TRAVEL DISTANCE


- B OCCUPANCY, SPRINKLERED
- MAX DISTANCE: 300 FEET
- MAX EXITING TRAVEL DISTANCE TO NEAREST EXIT ACCESS: 147
   FFFT

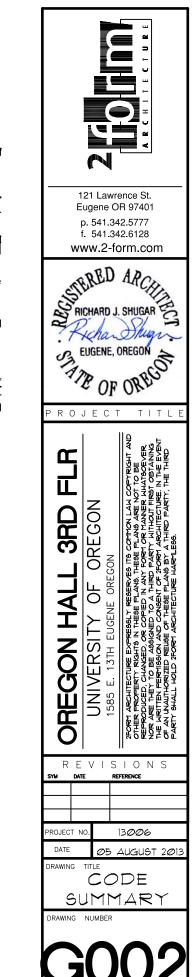

## ABBREVIATIONS

CTR CENTER PLY PLYWOOD  (D) DEMOLISH PLYWD PLYWOOD  DN DOWN PRE-FIN PRE-FINISHED  DWG DRAWING (R) REMOVE  (E) EXISTING S.F. SQUARE FEET  EA. EACH SHT. SHEET  EL. ELEVATION SIM. SIMILAR  EXT. EXTERIOR T.O. TOP OF  FDN. FOUNDATION TYP. TYPICAL  INT. INTERIOR U.N.O. UNLESS NOTED OTHERWISE  V.I.F. VERIFY IN FIELD  W.H. WATER HEATER	(D) DN DWG (E) EA. EL. EXT. FDN.	DEMOLISH DOWN DRAWING EXISTING EACH ELEVATION EXTERIOR FOUNDATION	PLYWD PRE-FIN (R) 5.F. 9HT. 9IM. T.O. TYP. U.N.O. Y.I.F.	PLYWOOD PRE-FINISHED REMOVE SQUARE FEET SHEET SIMILAR TOP OF TYPICAL UNLESS NOTED OTHERWISE VERIFY IN FIELD	ΞD
---	----------------------------------	---	---	---	----



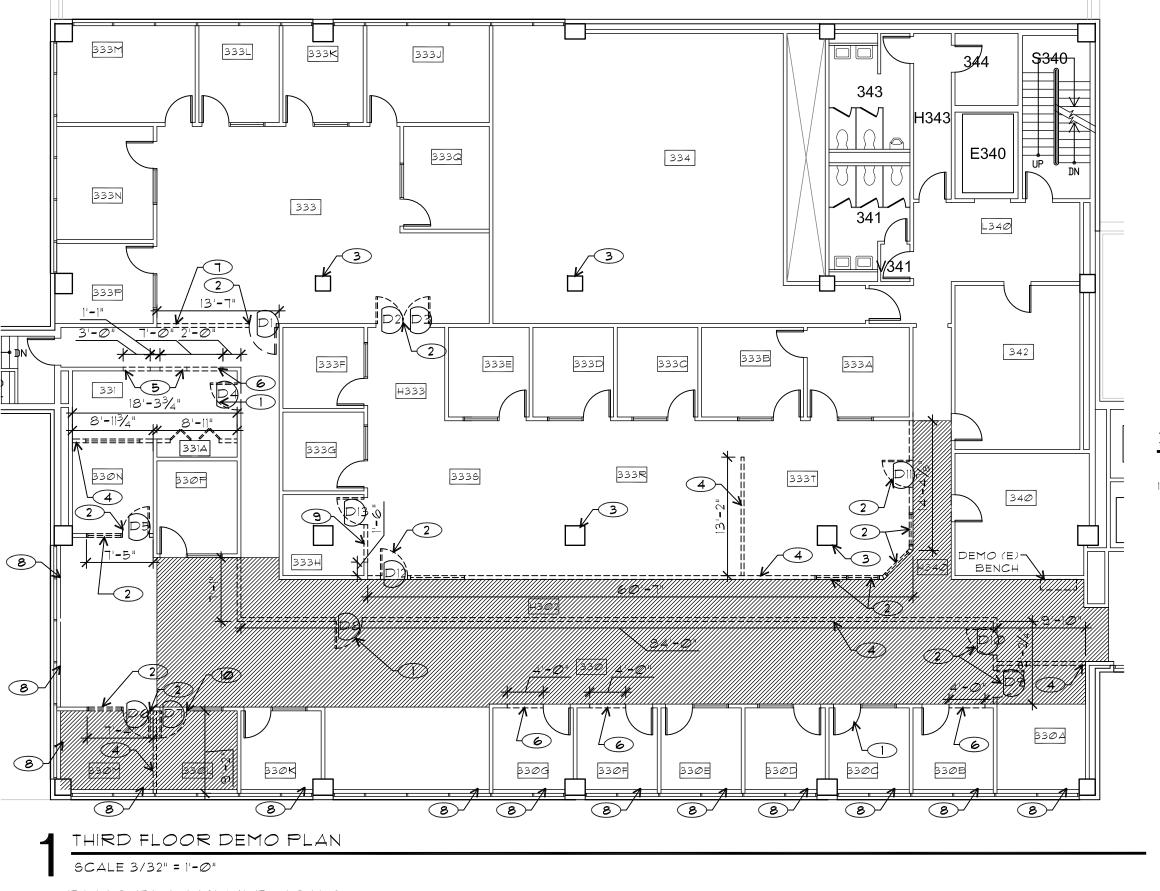

## DRAWING LEGEND

(E) WALL

DEMO WALL/DOOR/TRANSO RELITE



DEMO CARPET AND PAD



DOOR TYPE, SEE DOOR INVENTORY ON A601.

## DEMO GENERAL NOTES

SALVAGE ALL DEMOED DOORS, TRANSOMS, RELITES, WOOD WALL TRIM, WOOD DOOR TRIM AND SYSTEMS FURNITURE WALL BRACKETS AND STORE FOR FUTURE USE

121 Lawrence St. Eugene OR 97401 p. 541.342.5777 f. 541.342.6128 www.2-form.com

STERED ARCHITECTURE STEEL STEE EUGENE, OREGON OF OREGO

4

8 OREGON ಣ ¥

OF UNIVERSIT OREGON

REVISIONS REFERENCE

PROJECT N

13006 DATE Ø5 AUGUST 201.

DRAWING TITLE DEMO PLAN

## DEMO PLAN KEYED NOTES

- REMOVE DOOR, TRANSOM, AND DOOR/TRANSOM FRAME. (3) SALVAGE WHEN POSSIBLE. REFER TO DOOR SCHEDULE ON A601 FOR DETAILS.
- N.I.C: WORK BY OTHERS UNDER SEPARATE CONTRACT BY OWNER.

(E) COLUMN TO REMAIN


N.I.C: WORK BY OTHERS UNDER SEPARATE CONTRACT BY OWNER.

- N.I.C: WORK BY OTHERS UNDER SEPARATE CONTRACT BY OWNER.
  - N.I.C: WORK BY OTHERS UNDER SEPARATE CONTRACT BY OWNER.

N.I.C: WORK BY OTHERS UNDER

SEPARATE CONTRACT BY OWNER.

- REMOVE RADIATORS ALONG EXTERIOR WALLS.
- N.I.C: WORK BY OTHERS UNDER SEPARATE CONTRACT BY OWNER.
- 10 FLIP DOOR SWING

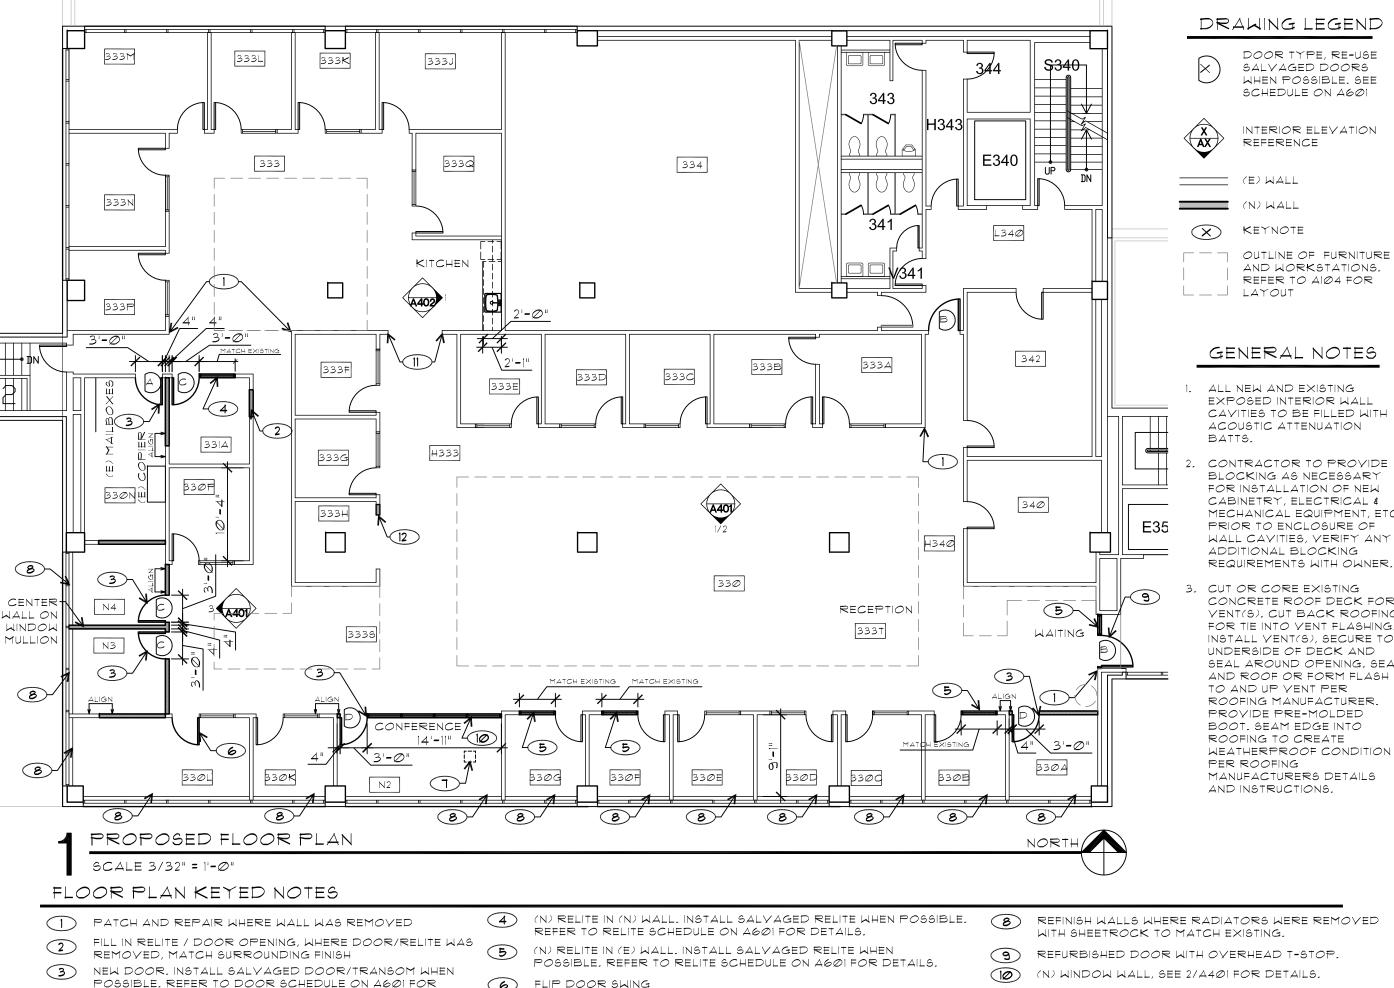

121 Lawrence St. Eugene OR 97401 p. 541.342.5777

f 541 342 6128 www.2-form.com

RICHARD J. SHUGAR EUGENE, OREGON OF OREGO

 $\square$ OREGON

品

<u>ෆ</u>

P

FOR INSTALLATION OF NEW CABINETRY, ELECTRICAL & MECHANICAL EQUIPMENT, ETC. WALL CAVITIES, VERIFY ANY

CONCRETE ROOF DECK FOR YENT(S), CUT BACK ROOFING FOR TIE INTO YENT FLASHING. INSTALL YENT(S), SECURE TO UNDERSIDE OF DECK AND SEAL AROUND OPENING, SEAM AND ROOF OR FORM FLASH ROOFING MANUFACTURER. WEATHERPROOF CONDITION MANUFACTURERS DETAILS

₹ Î SON RSI UNIVE! Ш 

REVISIONS DATE REFERENCE ROJECT N 13006 DATE Ø5 AUGUST 201

FLOOR PLAN

DRAWING NUMBER

FLIP DOOR SWING (6)

(1) OFOI PROJECTOR

DETAILS,

FRAME OPENING WITH APPROPRIATE BOX HEADER

FINISH OPENING WITH SHEETROCK TO MATCH EXISTING.



REQUIRED, SPRINKLER CONTRACTOR TO VERIFY LOCATIONS FOR (E) SPRINKLERS.



121 Lawrence St. Eugene OR 97401 p. 541.342.5777 f 541 342 6128 www.2-form.com




F OREGON 8 ಣ HALL 님 UNIVERSITY O OREGON

REVISIONS DATE REFERENCE

PROJECT NO 13006 DATE

Ø5 AUGUST 2013 PEFLECTED CEILING PLAN

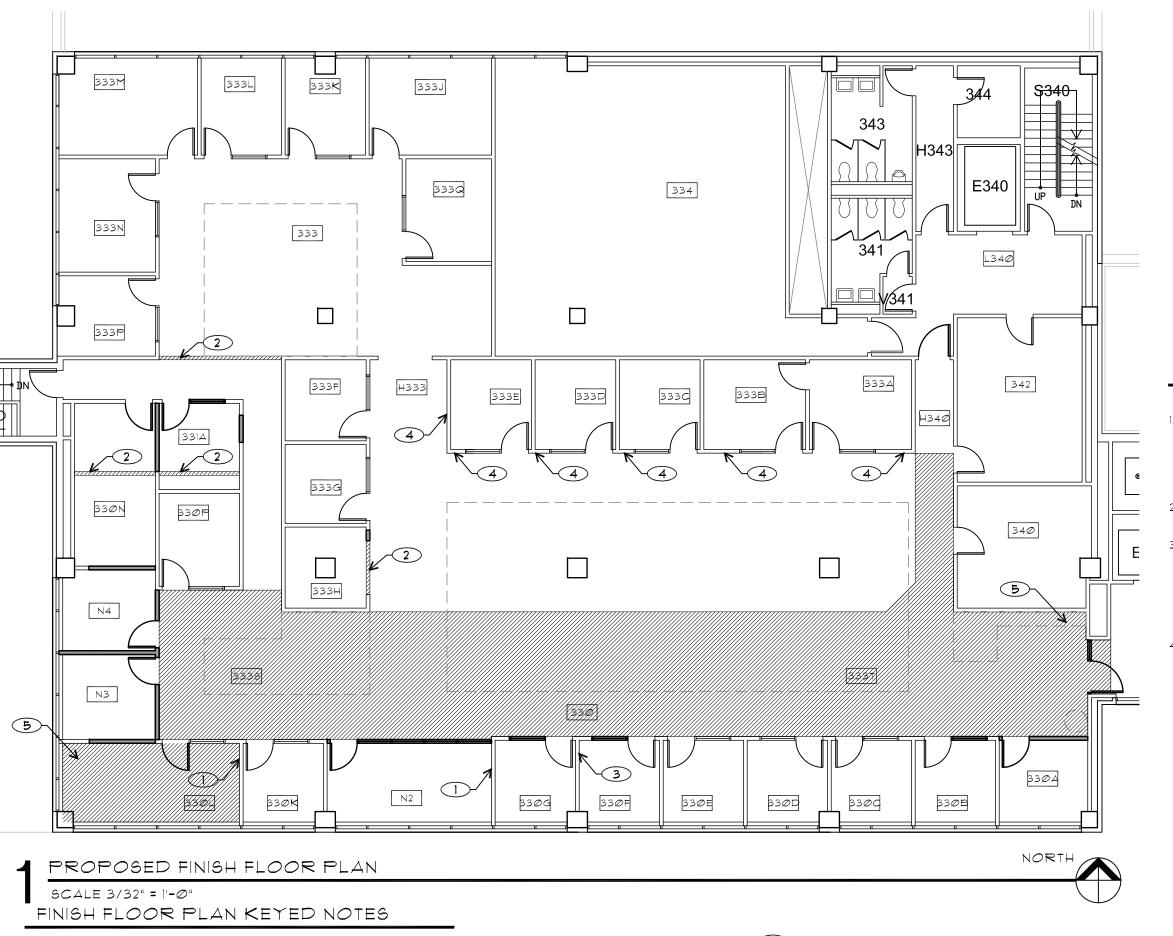

## DRAWING LEGEND

(X)

KEYNOTE



(N) CARPET, SEE SCHEDULE ON SHEET A602



(E) WALL (N) WALL



OUTLINE OF FURNITURE AND WORKSTATIONS. REFER TO AIØ4 FOR LAYOUT

## GENERAL NOTES

- ALL NEW WALLS TO BE PAINTED PT-1, BLEND NEW AND EXISTING PAINT WHERE REQUIRED, NEW TRIM TO MATCH EXISTING, REFER TO FINISH SCHEDULE ON SHEET A6Ø2.
- 2. MATCH EXISTING HISTORIC BASEBOARD THROUGHOUT.
- 3. PAINT ALL INSULATED AND EXPOSED PIPES / CONDUIT OCCURRING IN FINISHED AREAS TO MATCH BACKGROUND SURFACES, UNLESS OTHERWISE NOTED. DO NOT PAINT SPRINKLER.
- 4. WHERE NEW AND EXISTING FINISH SEAMS ARE EXPOSED, BLEND NEW TO MATCH EXISTING.



121 Lawrence St. Eugene OR 97401 p. 541.342.5777 f. 541.342.6128 www.2-form.com



OREGON 8 ന HALL

님 UNIVERSITY

OREGON REVISIONS

REFERENCE PROJECT NO 13006 DATE


Ø5 AUGUST 201. FINISH FLOOR

PLAN


- WHITEBOARD PAINT- SEE SCHEDULE ON SHEET A602
- PATCH AND REPAIR CARPET WITH CI WHERE WALLS WERE REMOVED, REFER TO SCHEDULE ON SHEET A6Ø2
- PAINT PT-1

(N) CARPET CI - SEE SCHEDULE ON SHEET A602


REPLACE (E) RUBBER BASEBOARD TRIM WITH HISTORIC WOOD

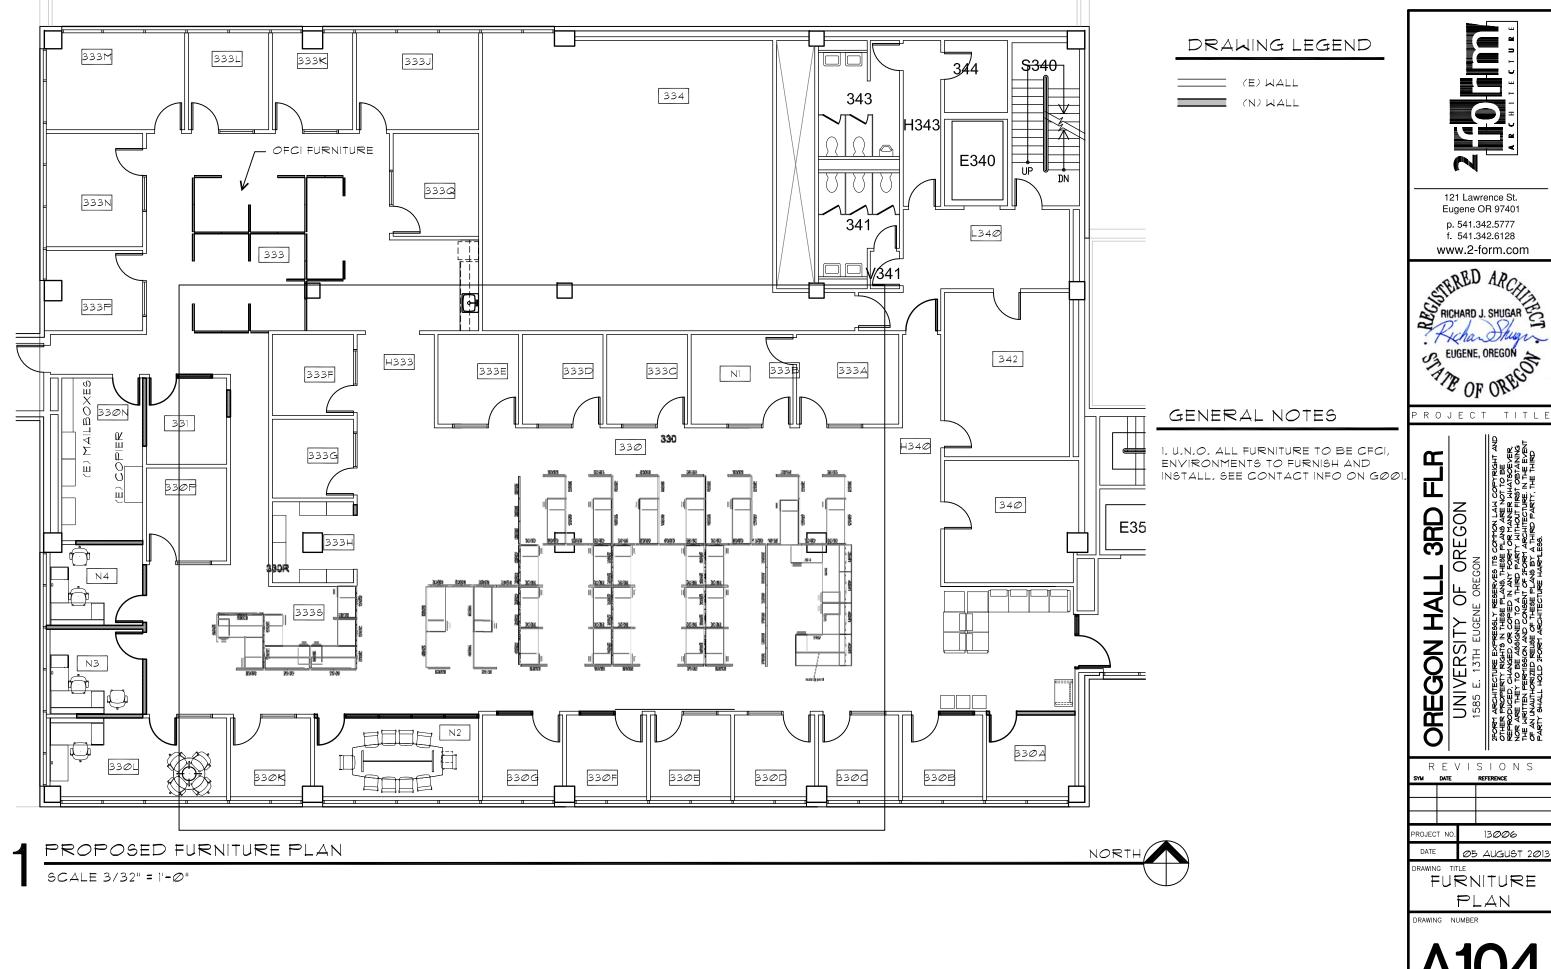


EUGENE, OREGON OF OREGON

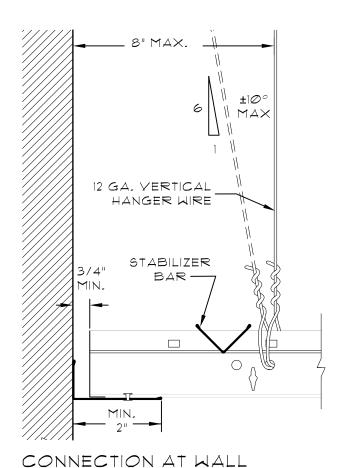

NOT TO SCALE

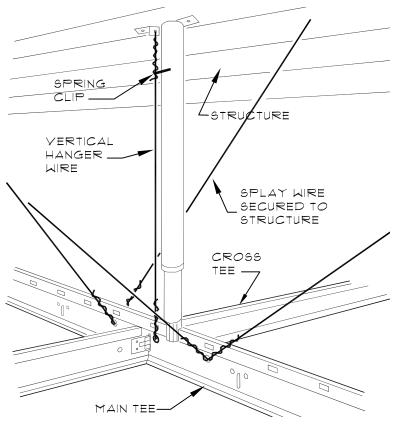


# AXON AT COMPRESSION POST

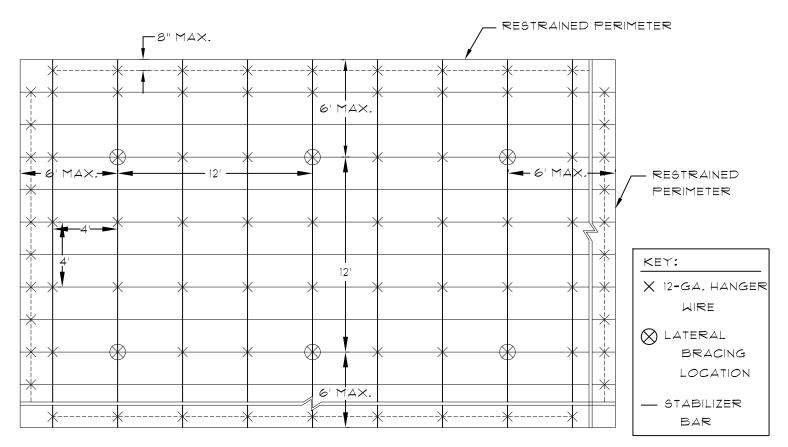

## ACOUSTICAL CEILING SEISMIC NOTES:

- MINIMUM INTERSECTION STRENGTH LIMITS @ MT/CT TO BE 180 LBS.
- VERTICAL HANGER WIRES TO BE 12 GAUGE @ 4' ON CENTER
- CONNECTION DEVICE FROM VERTICAL WIRE TO THE STRUCTURE ABOVE MUST SUSTAIN MIN. 100 LBS.
- HEAVY DUTY MAIN TEE CLASSIFICATION
- 1 IN 6 MAX PLUMB OF VERTICAL HANGER WIRES
- PERIMETER YERTICAL HANGER WIRES NOT MORE THAN 8" FROM WALL
- MIN 3 GRID END/WALL CLEARANCE
- MIN 2" PERIMETER CLOSURE (MOLDING) WIDTH
- GRID CONNECTION TO PERIMETER ATTACHED ON TWO ADJACENT WALLS
- PERIMETER TEE ENDS TIED TOGETHER AT PERIMETERS
- HORIZONTAL RESTRAINT (SPLAY WIRES OR RIGID BRACING) WITHIN 2" OF INTERSECTION AND SPLAYED 90° APART AT 45° ANGLES, REQUIRED FOR CEILINGS OVER 1000 SQ. FT.
- COMPRESSION POSTS (STRUTS) 12' O.C. IN BOTH DIRECTIONS, STARTING 6' FROM WALLS, REQUIRED FOR CEILINGS OVER 1000 SQ. FT.
- SPLAY BRACING CONNECTION STRENGTH MIN 200 LBS
- PARTITION ATTACHMENT BRACING INDEPENDENT OF CEILING SPLAY BRACING
- SEISMIC SEPARATION JOINT REQUIRED FOR AREAS GREATER THAN 2500 SQ.
- LIGHT FIXTURES TO BE MECHANICALLY ATTACHED TO GRID (TWO PER FIXTURE UNLESS INDEPEMDENTLY SUPPORTED)
- SPRINKLER HEADS AND OTHER PENETRATION CLEARANCE TO BE MIN 2" DIAMETER OPENING OR A SWING JOINT
- CABLE TRAYS AND ELECTRICAL CONDUIT TO BE INDEPENDENTLY SUPPORTED AND BRACED


NOTE: IMAGES ON THIS PAGE FROM USG CORPORATION CEILING LITERATURE

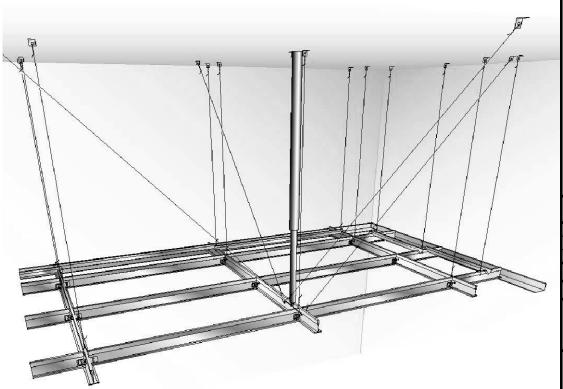

OVERALL 3D VIEW OF CEILING BRACING NOT TO SCALE



121 Lawrence St. Eugene OR 97401 p. 541.342.5777 f. 541.342.6128 www.2-form.com

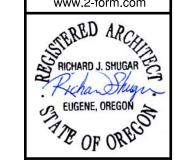

E E GON 380 ORE OF S S S S  $\overline{S}$ 


REVISIONS

OJECT N 13006 DATE Ø5 AUGUST 2013


TYP, CEILING

ONIVE!

BRACING

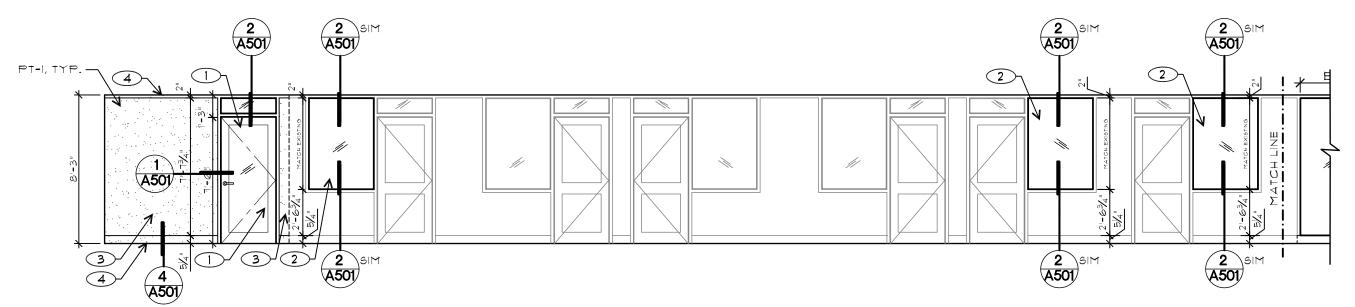


330 SOUTH ELEVATION- OFFICES 330A-330G

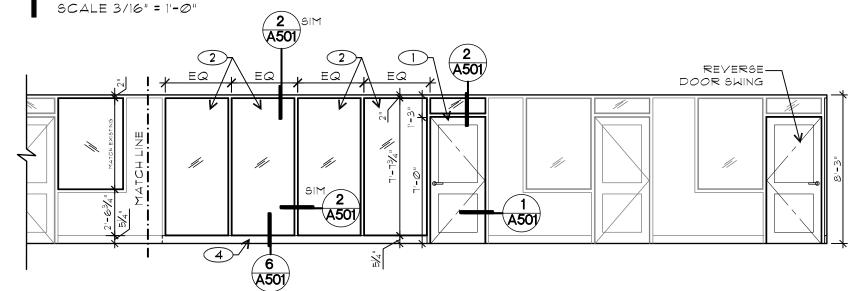

330 SOUTH ELEVATION- OFFICES 330G-330L

SCALE 3/16" = 1'-0"

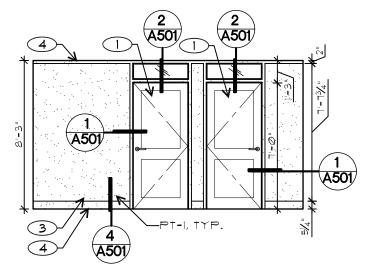

3336 W. ELEV. - OFFICES N3-N4


SCALE 3/16" = 1'-0"

## ELEVATION KEYED NOTES

- (N) DOOR, USE SALVAGED DOOR WHEN POSSIBLE. SEE DOOR SCHEDULE ON SHEET A601
- (N) RELITE, USE SALVAGED RELITE WHEN POSSIBLE
- (N) WALL, BLEND WALL FINISH WITH EXISTING.
- (N) TRIM, MATCH WITH EXISTING, SEE SCHEDULE ON SHEET A602



121 Lawrence St. Eugene OR 97401 p. 541.342.5777 f. 541.342.6128 www.2-form.com

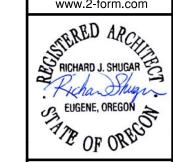


3RD OREGON OF UNIVERSITY O 1585 E. 13TH EUGENE ( 94 ARCHITECTURE EXPRESSELY RES) ER PROPERTY RIGHTS IN THESE PL. OREGON

REVISIONS REFERENCE

ROJECT NO 13006 DATE Ø5 AUGUST 2013

DRAWING TITLE INTERIOR ELEVATIONS

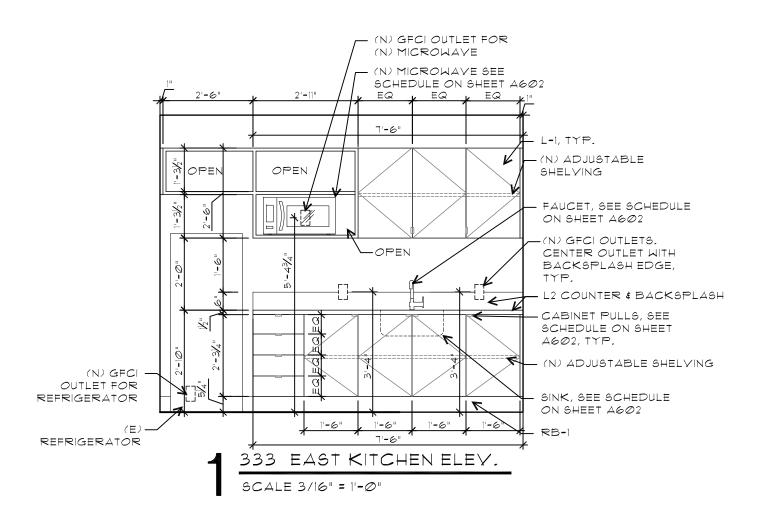


## ELEVATION KEYED NOTES

- (N) DOOR, USE SALVAGED DOOR WHEN POSSIBLE. SEE DOOR SCHEDULE ON SHEET AGO!
- (N) RELITE, USE SALVAGED RELITE WHEN POSSIBLE
- (N) WALL, BLEND WALL FINISH WITH EXISTING.
- (N) TRIM. MATCH WITH EXISTING, SEE SCHEDULE ON SHEET A602



121 Lawrence St. Eugene OR 97401 p. 541.342.5777 f. 541.342.6128 www.2-form.com

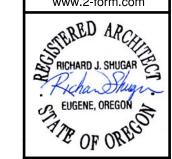

PROJECT TITL

DREGON HALL 3RD FLR
UNIVERSITY OF OREGON
1585 E. 13TH EUGENE OREGON
OTHER PROPERTY REJERVES ITS COPPOSITION LAW COPPRIGHT AND OTHER PROJECT OF THE PLANS ARE NOT TO BE REPROJECTED. CHANGED ON ANY FOOM OR HANNER MATRICECTER.
THEY TO BE ASSIGNED TO A THIRD PERTY MILITION THEY DETAILS.
THE METTER PERTY OF THE ASSIGNED TO A THIRD PERTY MILITION THEY DETAILS.
THE METTER PERTY OF THE ASSIGNED TO A THIRD PERTY MILITION THE OBJANNIA.
THE METTER PERTY OF A THIRD PERTY MILITION THE DETAIL THE PENTY.

R E V I S I O N S
SYM DATE REFERENCE

PROJECT NO. 13006


DATE 05 AUGUST 2013

DRAWING TILLE


DRAWING TITLE
INTERIOR
ELEVATIONS

DRAWING NUMBE


A402

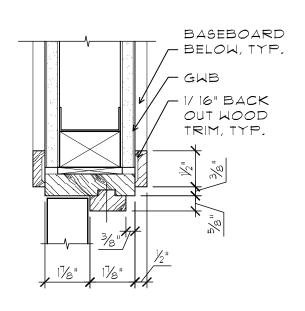




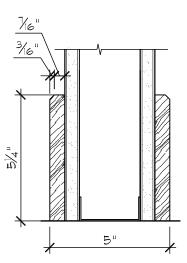


WOOD BASE, TYP.

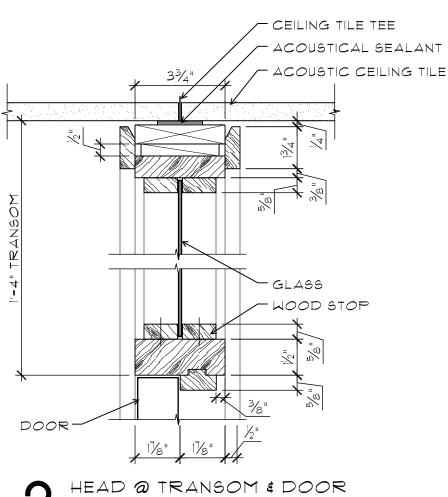


PEAD @ TRANSOM & DOOR SCALE 3" = 1'-0"

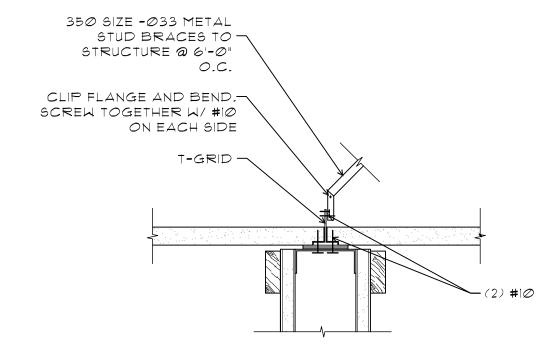

5 NEW PARTITION BRACING @ ACOUSTICAL TILE CEILING SCALE 3" = 1'-0"

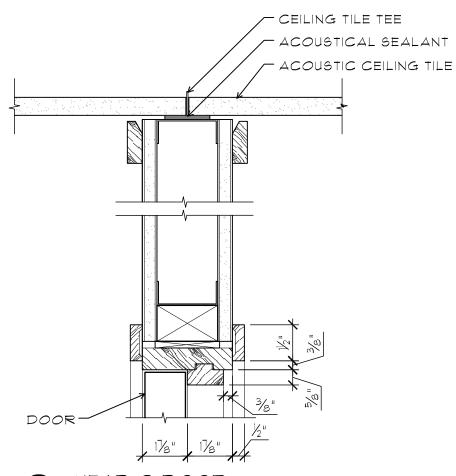



3 HEAD @ DOOR SCALE 3" = 1'-0"

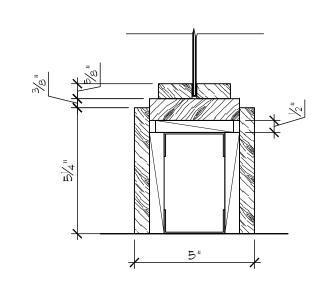

6 NEW RELITE SILL

SCALE 3" = 1'-0"

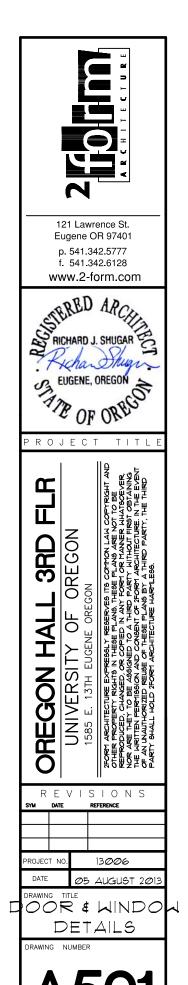

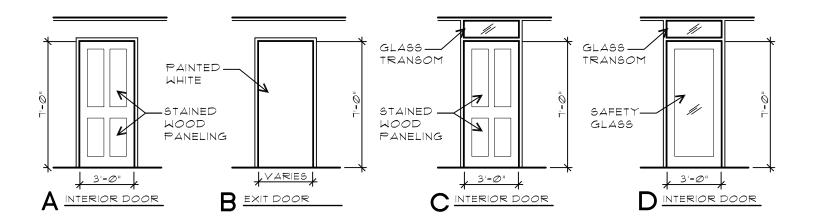

\* DOOR HARDWARE OFO!

## EXISTING DOOR INVENTORY

DOOR #	RM #	SIZE	DOOR TYPE (SEE A601)	MAT'L	FINISH	HAND	TRANSOM	NOTES
DEMO DOORS	7/-	100		-				
D1	333	3'-0"X7'-0"	В	sc	WHITE PAINT	LH	NO	EXIT DOOR
D2	333	3'-0"X7'-0"	В	sc	WHITE PAINT	LH	NO	EXIT DOOR. DOUBLE DOOR WITH D3
D3	333	3'-0"X7'-0"	В	sc	WHITE PAINT	RH	NO	EXIT DOOR. DOUBLE DOOR WITH D2
D4	331	3'-0"X7'-0"	A		WD STAIN	RH	NO	
D5	330N	3'-0"X7'-0"	С		WD STAIN	RH	YES	
D6	330M	3'-0"X7'-0"	С		WD STAIN	LH	YES	
D7	330L	3'-0"X7'-0"	С		WD STAIN	RH	YES	FLIP DOOR SWING ONLY
D8	330	3'-0"X7'-0"	А	sc	WD STAIN	RH	NO	
D9	330A	3'-0"X7'-0"	С		WD STAIN	LH	YES	
D10	330	3'-0"X7'-0"	A	sc	WD STAIN	RH	NO	
D11	333T	3'-0"X7'-0"	С	sc	WD STAIN	RH	YES	TRANSOM GLASS HAS ETCHED ACCENT DETAIL. IF RE-USED, REPLACE TRANSOM GLASS.
D12	3335	3'-0"X7'-0"	А	sc	WD STAIN	LH	NO	
D13	333H	3'-0"X7'-0"	A	sc	WD STAIN	RH	NO	

## NEW DOOR AND RELITE SCHEDULE

RM #	SIZE	DOOR TYPE (SEE A601)	MAT'L	FINISH	HAND	TRANSOM	NOTES
2227	3'-6"X7'-0"		66	WILLIE DAINE	Ī	110	REFURBISHED OFCI. CONTACT KEN STRAW FOR
333T	3-6"X7'-0"	В	SC	WHITE PAINT	LH	NO	DETAILS (541.346.5406)
H340	3'-0"X7'-0"	В	sc	WHITE PAINT	LH	NO	EXIT ONLY DOOR
330A	3'-0"X7'-0"	D	GLASS	WD STAIN	RH	YES	
N2	3'-0"X7'-0"	D	GLASS	WD STAIN	RH	YES	
330L	3'-0"X7'-0"	С	sc	WD STAIN	LH	YES	REVERSE DOOR SWING ONLY
N3	3'-0"X7'-0"	С	sc	WD STAIN	RH	YES	
N4	3'-0"X7'-0"	С	sc	WD STAIN	LH	YES	
330N	3'-0"X7'-0"	А	sc	WD STAIN	LH	NO	
331A	3'-0"X7'-0"	С	sc	WD STAIN	RH	YES	
NEW WII	NDOWS						
RM#	SIZE	MA-	r'L		FINISH		NOTES
330B	MATCH EXISTING	GLA	SS	MATCH EXISTIN	IG		SAFETY GLASS
330F	MATCH EXISTING	GLA	SS	MATCH EXISTIN	IG		SAFETY GLASS
330G	MATCH EXISTING	GLA	.SS	MATCH EXISTIN	MATCH EXISTING		SAFETY GLASS
331A	MATCH EXISTING	GLA	.ss	MATCH EXISTIN	IG		SAFETY GLASS
333T	WIDTH - LARGEST POSSIBLE. HEIGHT - ALIGN WITH TOP OF DOOR	GLA	SS	MATCH EXISTIN	IG		SAFETY GLASS
N2	SEE ELEVATION ON SHEET A401	GLA	.SS	MATCH EXISTIN	IG		SAFETY GLASS



121 Lawrence St. Eugene OR 97401 p. 541.342.5777 f. 541.342.6128 www.2-form.com



PROJECT TITL

OPEGON HALL 3RD FLR
UNIVERSITY OF OREGON
1585 E. 13TH EUGENE OREGON
3FORM ARCHITECTURE EXPRESSLY RESERVES ITS COMMON LAW CORPYRIGHT AND OTHER PROPERTY RIGHTS IN THESE PLANS ARE NOT TO BE REPRODUCED, CHARAGED, OR COPPED IN ANY TORST OR TRANSER MATABORYER, NOR ARE THEY TO BE ASSOCIATED TO BE ANY MATHORITECTURE. IN THE EVENT OF AN UNMATHORITED PRINE IN THE PARTY, THE THIRD PARTY. THE THIRD PARTY, THE THIRD PARTY. THE PARTY. THE THIRD PARTY. THE THIRD PARTY. THE THIRD PARTY. THE PARTY.

REVISIONS
SYM DATE REFERENCE

PROJECT NO. 13006

DATE 05 AUGUST 2013

DRAWING TITLE

DOR & MINDO

SCHEDULES

DRAWING NUMBER

A601

ROOM FINISH SCHEDULE

GWB = GYPSUM WALL BOARD RB = RESILIENT BASE PT = PAINT F = FACTORY FINISH U = UNFINISHED SC = SELF-COVE MDF = MEDIUM DENSITY FIBER BOARD

SG = SHEET GOOD CONC = CONCRETE PLY = PLYWOOD SHEATHING CT = CT TILE M = MARMOLEUM L = LAMINATE R = RUBBER BASE

#### \*\*\*NOTE: PAINT ALL NEW WALLS PT-1, BLEND NEW PAINT WITH EXISTING WHERE REQUIRED\*\*\*

RM #	ROOM NAME		FLOOR			CEILING	REMARKS	
		MAT'L	COLOR / FINISH	BASE	MAT'L	COLOR / FINISH	MOULDING	
333S	CUBICLES	NEW CT	C-1	B-1	ACT	NA	B-1	
333T	RECEPTION	NEW CT	C-1	B-1	ACT	NA	B-1	
331A	OFFICE	EXIST CT/ NEW CT	C-1	B-1	ACT	NA	B-1	SEE A103 FOR CARPET PATCH AND REPAIR AREAS
330	ENCLOSED CUBICLES	EXIST CT/ NEW CT	C-1	B-1	ACT	NA	B-1	
330A	OFFICE	EXIST CT	NA	B-1	ACT	NA	B-1	
330B	OFFICE	EXIST CT	NA	B-1	ACT	NA	B-1	
330F	OFFICE	EXIST CT	NA	B-1	ACT	NA	B-1	PAINT WEST WALL PT-1
330G	OFFICE	EXIST CT	NA	B-1	ACT	NA	B-1	
N2	CONFERENCE	EXIST CT	NA	B-1	ACT	NA	B-1	PAINT EAST WALL PT-2
N3	OFFICE	EXIST CT	NA	B-1	ACT	NA	B-1	
N4	OFFICE	EXIST CT	NA	B-1	ACT	NA	B-1	
330L	OFFICE	NEW CT	C-1	B-1	ACT	NA	B-1	PAINT EAST WALL PT-2
330N	OFFICE	EXIST CT/ NEW CT	C-1	B-1	ACT	NA	B-1	SEE A103 FOR CARPET PATCH AND REPAIR AREAS
H340	HALLWAY	EXIST CT/ NEW CT	C-1	B-1	ACT	NA	B-1	

ALL-IN-ONE SCHEDULE

Symbol	Manuf.	Product	Color/Texture/Finish	Quantity	Description
FINISHES				6.	
PT-1	TBD	Low-VOC interior latex paint	Eggshell (Match Benjamin Moore 2151-70 Powder Sand)	Verify	Wall and ceiling paint
PT-2	Idea Paint	Idea Paint CREATE	White	Verify	whiteboard paint
C-1	Interface FLOR	Architectural Plans; To Scale/Elevations; 14652	Color: 7765	265 s.f. new, + patching	Modular carpet tiles. Refer to floor plan for new carpet locations
L-1	Formica	8825-58	Platinum Drops in matte finish	Verify	Run linear pattern vertically
L-2	Formica	5882-58	Citadel Warp in Matte Finish	Verify	
RB-1	Roppe	Coved Rubber Base	Finish: Satin, Color: 123 Charcoal	Verify	Kitchenette base
B-1	Contractor	5 1/4" wood base	match existing	Verify	Profile and dimensions to match existing historic. See 4/A501 for detail
B-2	Contractor	13/4" wood moulding	match existing	Verify	Profile and dimensions to match existing historic. Refer to detail 2/A501.
KITCHENETTE				re:	-1
Microwave	Panasonic	Full Size 1.6 Cu. Ft. 1250W Microwave Oven	White	1	(W) 21.9" X (H)12" X (D)19.4"
Paper Towel Dispenser					OFCI
Soap Dispencer					OFCI
Cabinet pulls	Hafele	2" Centers Edge Pull (HAF-59902)	Anodized Silver	Verify	Cabinet pulls for new casework
Kitchen sink	American Standard	7501.103.075, Culinaire 25-Inch self- rimming Single Bowl Kitchen Sink	Stainless Steel	1	
Faucet	Moen	7175 Series Single Handle High Arc Pull Out Kitchen Faucet	Stainless Steel	1	



121 Lawrence St. Eugene OR 97401 p. 541.342.5777 f. 541.342.6128 www.2-form.com



L 3RD I UNIVERSITY OF 1585 E. 13TH EUGENE ORE

OREGON HALL REVISIONS REFERENCE

PROJECT NO 13006

Ø5 AUGUST 2013 DRANIC LTITE NONE &

FINISH

## ELECTRICAL LEGEND

DUPLEX RECEPTACLE

FOURPLEX

NETWORK FACEPLATE

JUNCTION BOX  $\bigcirc$ 

SURFACE RACEWAY

MAGNETIC DOOR HOLDER

SINGLE POLE SWITCH

THREE WAY SWITCH

BRANCH CIRCUIT PANEL BOARD

EXISTING TO REMAIN

NOTE REFERENCE

RECESSED RELOCATED FLUORESCENT LIGHT FIXTURE

RECESSED RELOCATED FLUORESCENT LIGHT FIXTURE ON EMERGENCY CIRCUIT

EXISTING 2X4 FIXTURE TO REMAIN AT EXISTING LOCATION

EMERGENCY EXIT SIGN

WIRE MOLD 4000 OUTLETS AS INDICATED

AIR CONDITIONER OUTLET ܣ

OVERHEAD PROJECTOR  $\vdash$ 

FAN & SWITCH

CEILING MOUNTED OCCUPANCY SENSOR

WALL MOUNTED OCCUPANCY SENSOR 09

(N) WALL WASHER

SPRINKLER

SPRINKLER BELL 0,


RELOCATE

NEW LOCATION

EXISTING TO REMAIN


REMOVE (R)

(N) CEILING FAN

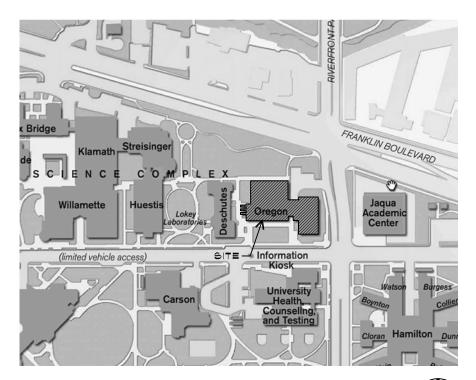



EUGENE, OREGON

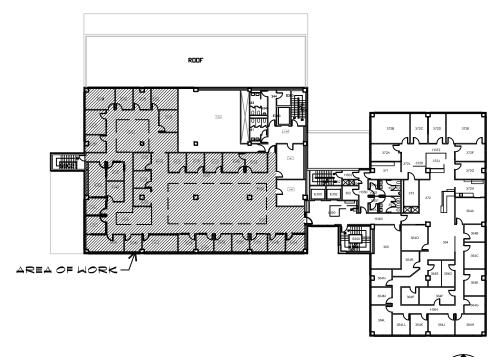


KEY PLAN SCALE: 1" = 50'0'




### GENERAL NOTES

- 1. COMPLY WITH ALL CODES, ORDINANCES, AND GOVERNMENT AGENCIES.
- 2. ALL CONSTRUCTION IS TO COMPLY WITH THE 2010 OREGON STRUCTURAL SPECIALTY CODE, AS AMENDED BY THE STATE OF OREGON.
- 3. DIMENSIONS ARE TO FACE OF FINISH OR CASEWORK, UNLESS NOTED OTHERWISE.
- 4. YERIFY AND COORDINATE WITH PLUMBING, MECHANICAL, AND ELECTRICAL.
- 5. DO NOT SCALE DRAWINGS. CONTRACTOR SHALL RELY ON WRITTEN DIMENSIONS AS GIVEN, THE CONTRACTOR SHALL NOTIFY THE ARCHITECT FOR CLARIFICATIONS. ALL DIMENSIONS SHALL BE FIELD VERIFIED BY CONTRACTOR & COORDINATED W/ THE WORK OR TRADES. IF DISCREPANCIES ARE FOUND, THE CONTRACTOR SHALL NOTIFY THE ARCHITECT BEFORE THE COMMENCEMENT OR RESUMPTION OF WORK.
- 6. IF THE CONTRACTOR DISCOVERS AT ANY TIME THAT REQUIREMENTS OF THIS CONTRACT CONFLICT W/ OR ARE IN VIOLATION OF APPLICABLE LAWS, CODES, REGULATIONS & ORDINANCES, HE SHALL NOT PROCEED W/ WORK IN QUESTION UNTIL ARCHITECT HAS BEEN NOTIFIED IN WRITING & WRITTEN DETERMINATION IS MADE BY THE ARCHITECT, WHERE COMPLETED OR PARTIALLY COMPLETED WORK IS FOUND TO BE IN VIOLATION W/ APPLICABLE LAWS, CODES, REGULATIONS OR ORDINANCES, CONTRACTOR SHALL BE REQUIRED TO REMOVE THAT WORK FROM THE PROJECT & REPLACE SUCH WORK W/ ALL NEW COMPLYING WORK AT NO ADDITIONAL COST TO THE OWNER OR ARCHITECT.
- 7. CONTRACTOR SHALL PROVIDE & INSTALL STIFFENERS, BRACING, BACK-UP PLATES & SUPPORTING BRACKETS REQUIRED FOR THE INSTALLATION OF FLOOR-MOUNTED OR SUSPENDED MECHANICAL & ELECTRICAL EQUIPMENT.
- 8. CONTRACTOR SHALL VERIFY THE LOCATIONS OF EXISTING UTILITIES BELOW FLOOR LEVEL & RELATED SERVICE CONNECTIONS W/ THE RESPECTIVE UTILITY COMPANIES.
- 9. SHOP DRAWINGS SHALL BE SUBMITTED FOR EQUIPMENT & MATERIALS WHICH MUST INTERFACE & COORDINATE W/ OTHERS, WHETHER DETAILED OR NOT
- 10. PATCH AND REPAIR STRUCTURE, FRAMING, AND FINISHES AFFECTED BY CONSTRUCTION.
- II. ALL UNFINISHED FACES AND EDGES, WHETHER EXPOSED OR NOT, OF ALL CASEWORK, COUNTERTOPS, SHELVING, SYSTEMS FURNITURE, ETC. SHALL BE SEALED WITH SAFECOAT SAFE SEAL PARTICLE BOARD AND PLYWOOD SEALER.
- 12. NETWORK DROPS TO BE PROVIDED BY OWNER. CONTRACTOR TO COORDINATE W/ OWNER.

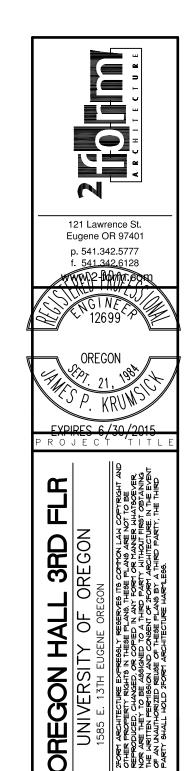



DRAWING NUMBER

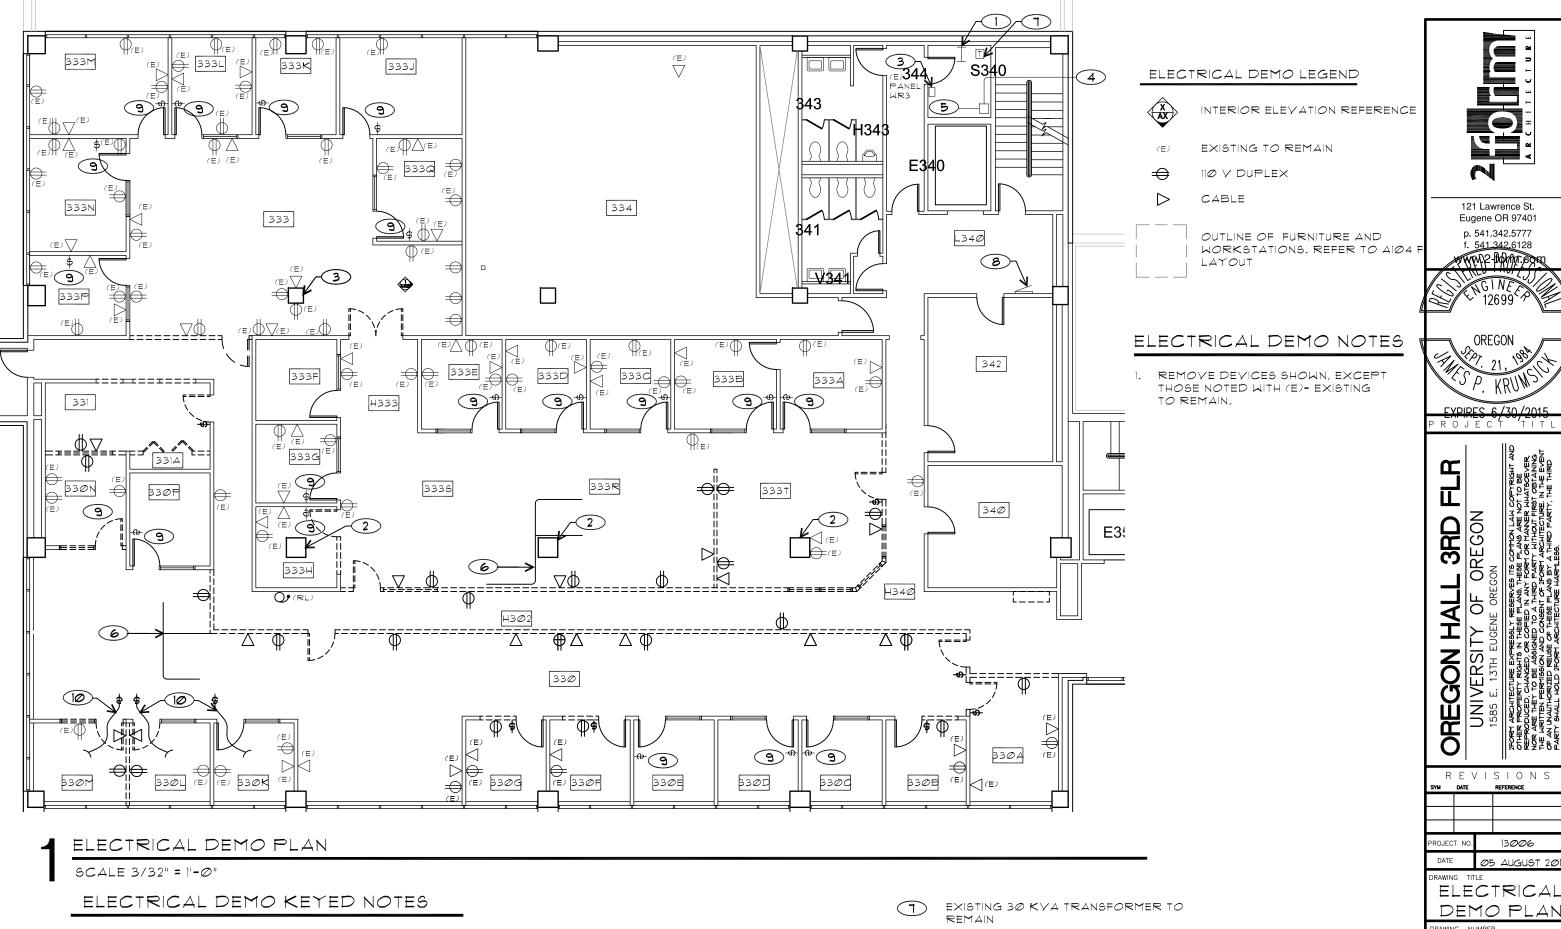

DISCONNECT WALL MOUNTED TRANSFORMER AND REMOVE

REMOVE EXISTING WALL MOUNTED TRANSFORMER

DISCONNECT POWER AND DATA CONNECTIONS

EXISTING LANDSCAPE PARTITION TO BE REMOVED -

FEEDER FROM (E) PANEL WL3

EXISTING NETWORK EQUIPMENT RACK

(E) COLUMN TO REMAIN

(E) PANEL WR3 TO BE RE-FED

EXISTING PANEL 342 TO REMIAIN

EXISTING SWITCH TO REMAIN UNDER BASE BID AND TO BE REMOVED UNDER ALTERNATE BID. 121 Lawrence St.

Eugene OR 97401 p. 541.342.5777

f. 541.342.6128

WWY2 BOMMERS

OREGON

OF


UNIVERSITY

REFERENCE

13006

Ø5 AUGUST 201

CEILING MOUNTED SWITCH

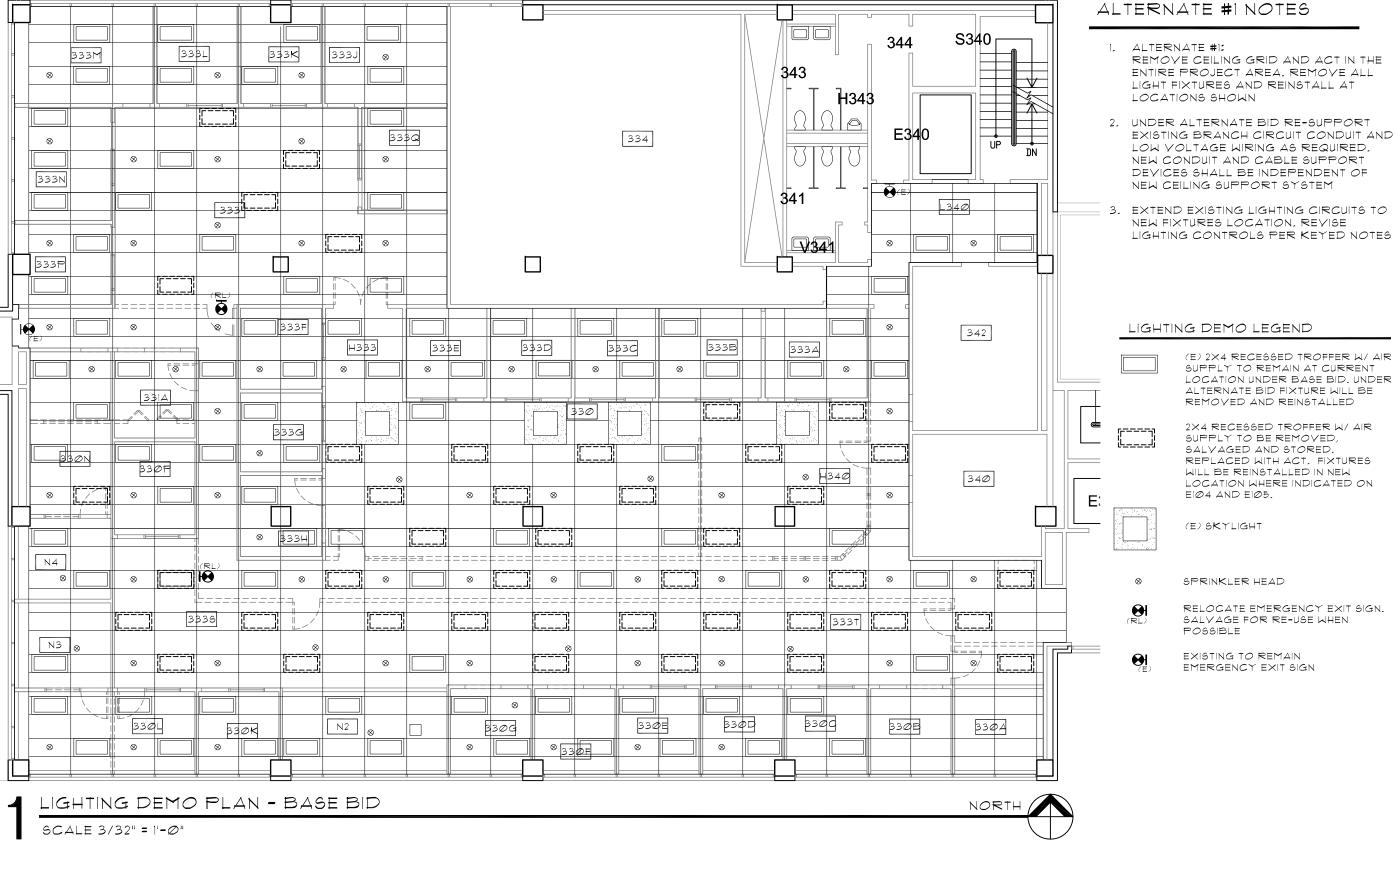

REMOVE CEILING GRID AND ACT IN THE ENTIRE PROJECT AREA, REMOVE ALL LIGHT FIXTURES AND REINSTALL AT

EXISTING BRANCH CIRCUIT CONDUIT AND LOW YOLTAGE WIRING AS REQUIRED. NEW CONDUIT AND CABLE SUPPORT DEVICES SHALL BE INDEPENDENT OF

LIGHTING CONTROLS PER KEYED NOTES

SUPPLY TO REMAIN AT CURRENT LOCATION UNDER BASE BID. UNDER ALTERNATE BID FIXTURE WILL BE

2X4 RECESSED TROFFER W/ AIR REPLACED WITH ACT, FIXTURES LOCATION WHERE INDICATED ON



121 Lawrence St. Eugene OR 97401 p. 541.342.5777 f. 541.342.6128 WW/2 BOMMESON

12699

EVDIDES 6/30/2015

F OREGON 8 ಣ

님

UNIVERSITY

REVISIONS DATE REFERENCE


PROJECT NO

HALL

OREGON

13006 DATE Ø5 AUGUST 2013

LIGHTING DEMO PLAN

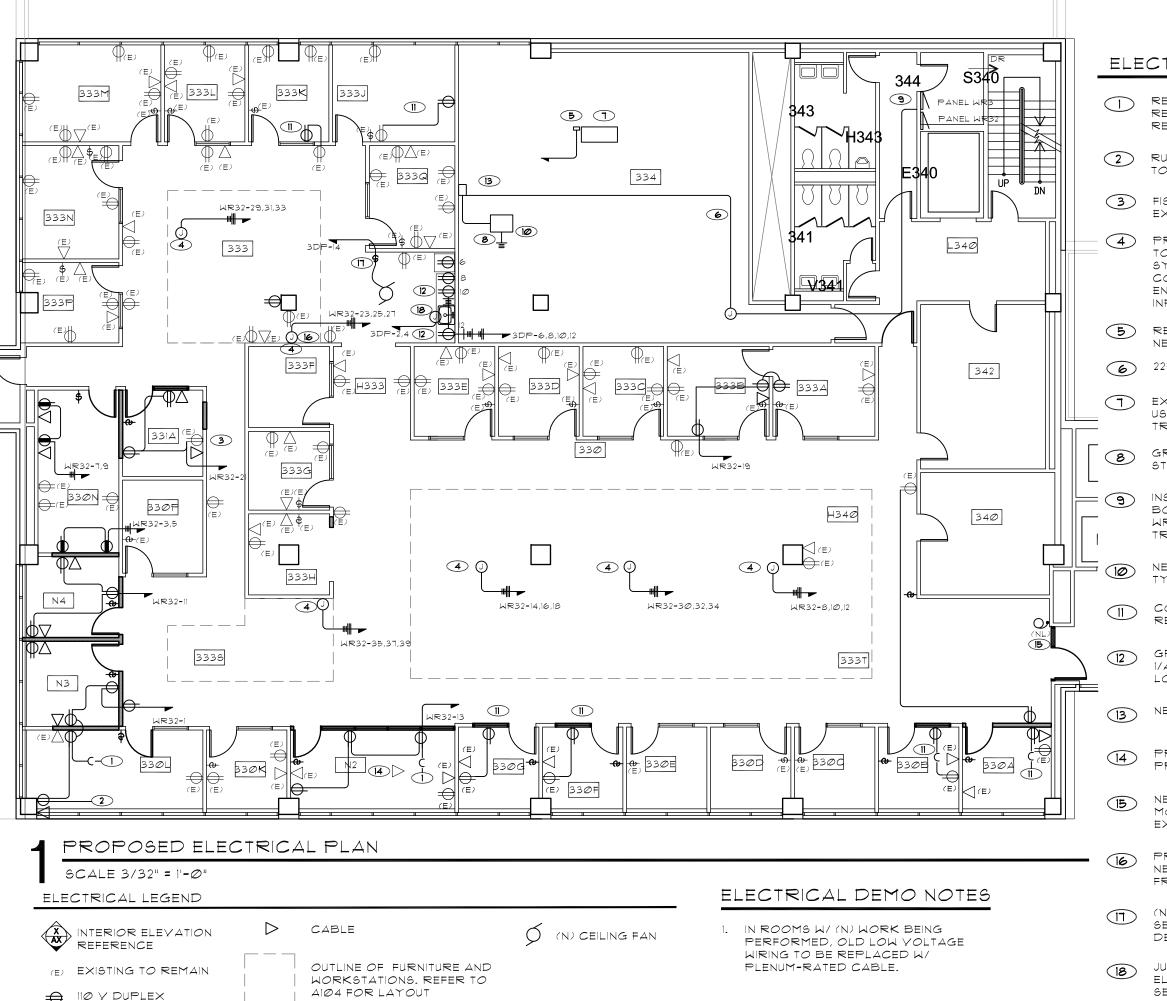

## ELECTRICAL KEYED NOTES

- RECONNECT EXISTING ROOM
  RECEPTACLE CIRCUIT TO NEW
  RECEPTACLES
- 2 RUN WIREMOLD 4000 ON COLUMN TO TO NEW POWER AND DATA OUTLETS
- FIGH RECEPTACLE BRANCH CIRCUIT IN EXISTING WALL
- PROVIDE ELECTRICAL CONNECTION
  TO NEW LANDSCAPE PARTITION
  SYSTEM FROM NEW POWER POLE,
  COORDINATE LOCATIONS WITH
  ENVIRONMENTS, SEE GOOI FOR CONTACINFORMATION
- 5 REFEED EXISTING DDC PANEL FROM NEW PANELBOARD.
- 6 225 AMP FEEDER TO NEW PANEL WR3
- EXISTING MOTOR CONTROL CENTER.

  USE SPARE BUCKET TO SERVE NEW

  TRANSFORMER.
- GROUND TRANSFORMER TO BUILDING STEEL.
- INSTALL SECOND 120/208V PANEL BOARD WR32 AND FEED BOTH WR3 AND WR32 FROM NEW DRY TYPE TRANSFORMER
- NEW 75 KVA 480: 208Y/A120V DRY TYPE TRANSFORMER
- CONNECT TO EXISTING ROOM RECEPTACLE CIRCUIT
- GFCI OUTLET, REFER TO ELEVATION
  1/A402 FOR ELECTRICAL OUTLET
  LOCATIONS.
- NEW 225 AMP MAIN BREAKER PANEL.
- PROVIDE DATA IN CEILING FOR OFOI PROJECTOR
- NEW LOCATION FOR SPRINKLER MONITORING SYSTEM AUDIBLE DEVICE. EXTEND EXISTING CIRCUIT AS REQUIRED
- PROVIDE ELECRICAL CONNECTION TO NEW LANDSCAPE PARTITION SYSTEM FROM NEW FLUSH WALL BOX
- (N) TIMER SWITCH FOR (N) CEILING FAN. SEE MECHANICAL SPECIFICATIONS FOR DETAILS.
- JUNCTION BOX FOR UNDER SINK ELECTRIC, TANKLESS WATER HEATER, SEE MECHANICAL SPECS FOR DETAILS



121 Lawrence St. Eugene OR 97401 p. 541.342.5777

f. 541.342.6128

OREGON

EXPIRES 6/30/2015

CPTRIGHT AND TTO BE AT TO SECRET AND STANDARY OF THE SPENT OF THE SPEN

HALL 3RD FLF

TY OF OREGON

JGENE OREGON

SEBLY RESERVES ITS COMMON LAW COPYRIGH

THESE PLANS THESE PLANS FOR IN THE RE THE PLANS THESE THAN THE PLANS THE PLANS THE PLANS THE PLANS TO BE

THE PLANS THE PLANS THE PLANS TO BE PLANS

THE PLANS THE PLA

OREGON HALL 3
UNIVERSITY OF ORE
1585 E. 13TH EUGENE OREGON
2004T REPROPERTY REALTH IN THESE PLANS, THESE PINS
OTHER PROPERTY REALTH IN THESE PLANS, THESE PINS
OTHER PROPERTY REALTH IN THESE PLANS, THESE PINS
ONE ARE THEY TO BE ASSIGNED TO A THIRD PARKY.

REVISIONS M DATE REFERENCE

DATE REFERENCE

ROJECT NO. 13006


DATE 05 AUGUST 201

DRAWING TITLE
ELECTRICAL

PLAN

WING NUMBER

E103

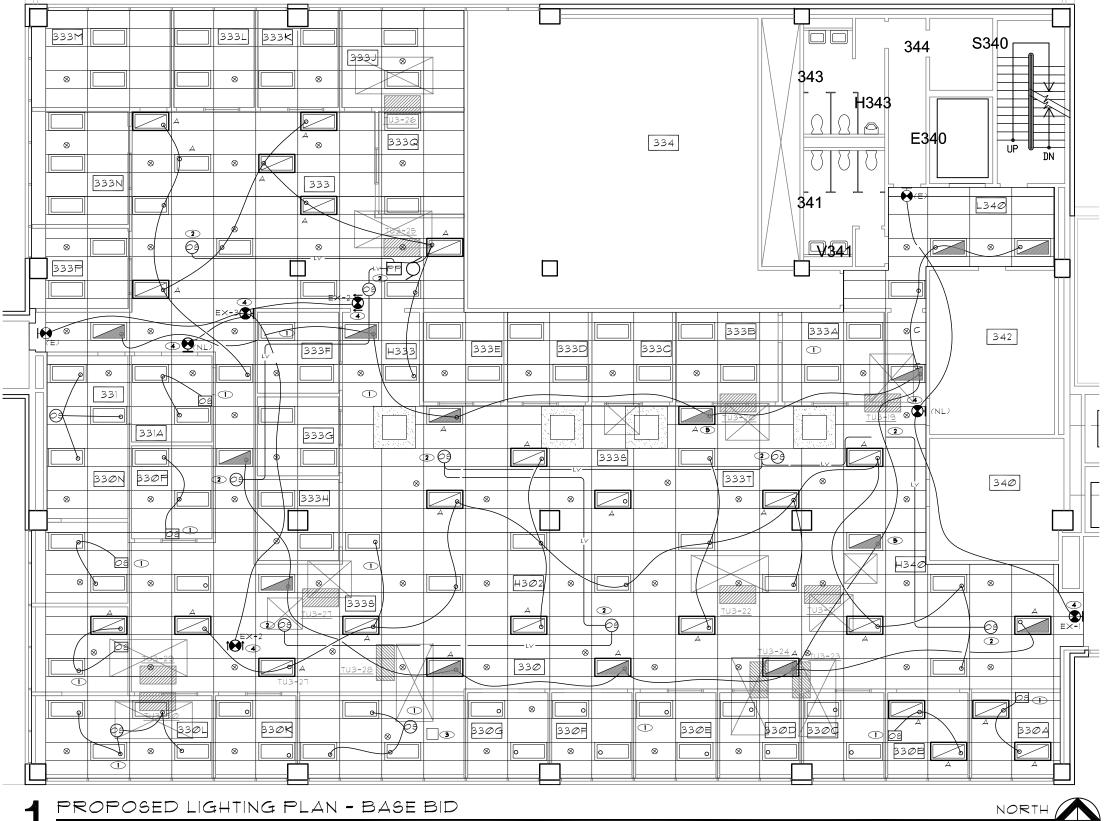

SCALE 3/32" = 1'-0"

## LIGHTING PLAN KEYED NOTES

- PROVIDE NEW LINE YOUTAGE OCCUPANCY SENSOR CONTROL OF ROOM LIGHTING
- CONTROL OPEN OFFICE LIGHTING CIRCUIT FROM NEW POWER PACK AND LOW YOLTAGE OCCUPANCY SENSORS

NOT USED

EXTEND EMERGENCY CIRCUIT TO NEW EGRESS LIGHT FIXTURES

## GENERAL NOTES

- 1. SEE EIØ5 FOR LIGHTING PLAN ALTERNATE #1.
- 2. INSTALL (N) CEILING TILES, SALYAGED WHEN POSSIBLE, WHERE LIGHT FIXTURES WERE REMOVED.
- 3. FIRE ALARM SYSTEM TO MEET REQUIREMENTS OF NFPA 72 WHERE REQUIRED, SPRINKLER CONTRACTOR TO ADVISE IF AND WHERE (N) SPRINKLERS ARE TO BE INSTALLED AND VERIFY LOCATIONS FOR (E) SPRINKLERS, NEW FIRE ALARM ANNUNCIATION DEVICES TO BE DESIGN-BUILD AND INSTALLED BY OTHERS UNDER SEPARATE CONTRACT WITH OWNER.
- 4. IN ROOMS W/ (N) WORK BEING PERFORMED, OLD LOW YOLTAGE WIRING TO BE REPLACED W/ PLENUM-RATED CABLE.

### LIGHTING PLAN LEGEND

(E) 2×4 RECESSED TROFFER W/ AIR SUPPLY

(E) FIXTURE, NEW LOCATION- 2X4 RECESSED TROFFER W/ AIR SUPPLY



(E) FIXTURE, NEW LOCATION- 2X4 RECESSED TROFFER ON EMERGENCY CIRCUIT W/ AIR SUPPLY



(E) SKYLIGHT

SPRINKLER HEAD

EMERGENCY EXIT SIGN, EXISTING TO REMAIN.

 $\mathbb{Z}_{+\times}$ 

EMERGENCY EXIT SIGN, NEW. SALVAGE DEMOED FIXTURES WHEN POSSIBLE, SEE SCHEDULE ON EIØ1

(N) CEILING FAN



Eugene OR 97401 p. 541.342.5777 f 541.342.6128

MAN BOWN COR 12699



4

OREGON 品  $\overline{\mathbf{c}}$ 

P ¥ SON

UNIVERSITY


REVISIONS DATE REFERENCE

PROJECT NO 13006 DATE Ø5 AUGUST 201

DRAWING LIGHTING PLAN

DRAWING NUMBER

EXTEND EXIT SIGN CIRCUIT TO NEW EXIT SIGNS

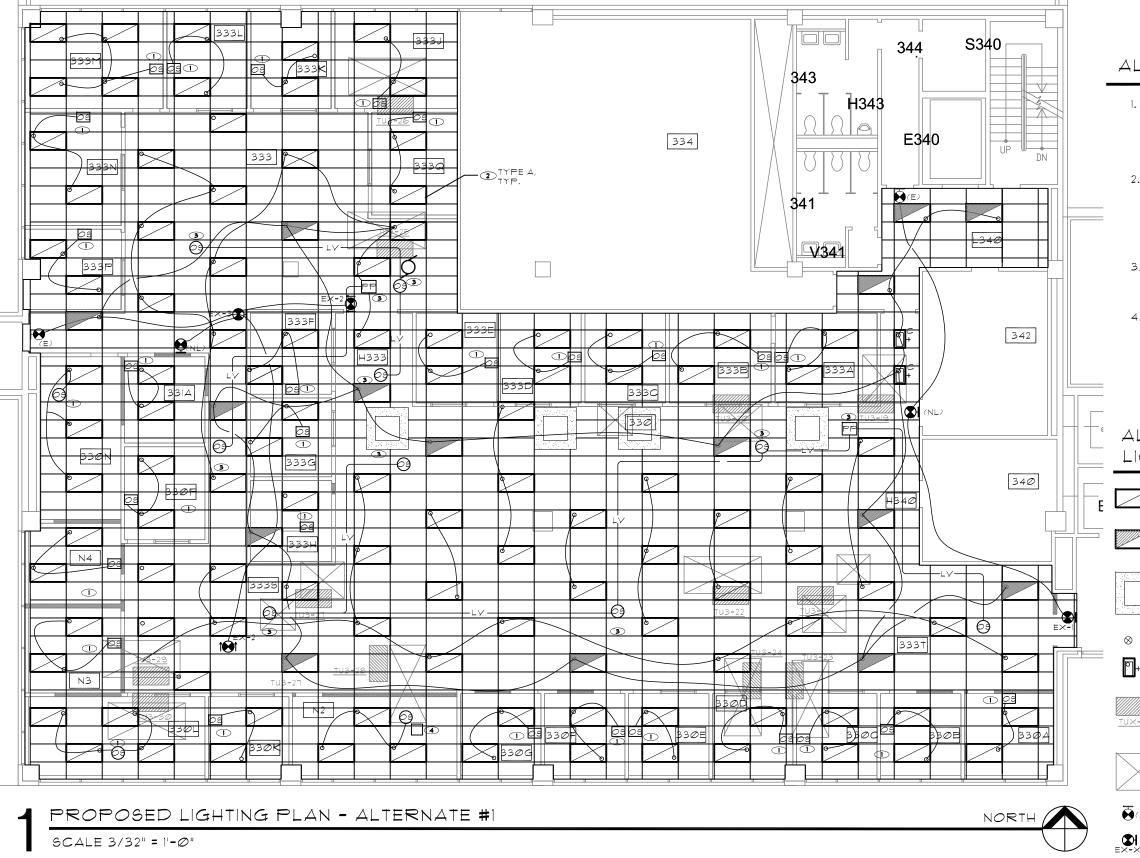

## ALTERNATE #1 NOTES

- 1. ALTERNATE #1: LIGHT FIXTURES AND REINSTALL AT LOCATIONS SHOWN
- 2. UNDER ALTERNATE BID RE-SUPPORT LOW YOLTAGE WIRING AS REQUIRED. NEW CONDUIT AND CABLE SUPPORT DEVICES SHALL BE INDEPENDENT OF
- NEW FIXTURES LOCATION, REVISE
- PERFORMED, OLD LOW YOLTAGE WIRING TO BE REPLACED W/ PLENUM-RATED CABLE.

# LIGHTING PLAN LEGEND

(E) FIXTURE, NEW LOCATION- 2X4 RECESSED TROFFER ON

(E) SKYLIGHT

SPRINKLER HEAD

(N) WALL WASHER

TERMINAL UNIT

MECHANICAL ACCESS PANEL

EMERGENCY EXIT SIGN, EXISTING TO REMAIN.

> SALVAGE DEMOED FIXTURES WHEN POSSIBLE.

(N) CEILING FAN

- REMOVE CEILING GRID AND ACT IN THE ENTIRE PROJECT AREA, REMOVE ALL
- EXISTING BRANCH CIRCUIT CONDUIT AND NEW CEILING SUPPORT SYSTEM
- 3. EXTEND EXISTING LIGHTING CIRCUITS TO LIGHTING CONTROLS PER KEYED NOTES
- 4. IN ROOMS W/ (N) WORK BEING

# ALTERNATE #1

(E) FIXTURE, NEW LOCATION- 2X4 RECESSED TROFFER W/ AIR SUPPLY

EMERGENCY CIRCUIT W/ AIR SUPPLY

 $\otimes$ 







EMERGENCY EXIT SIGN, NEW.



EXTEND EMERGENCY

LIGHT FIXTURES

CIRCUIT TO NEW EGRESS

# LIGHTING PLAN KEYED NOTES

- PROVIDE NEW LINE VOLTAGE OCCUPANCY SENSOR CONTROL OF ROOM LIGHTING
- NEW LOCATION OF EXISTING 2X4 RECESSED FLUORESCENT FIXTURE
- CONTROL OPEN OFFICE LIGHTING CIRCUIT FROM NEW POWER PACK AND LOW YOLTAGE OCCUPANCY SENSORS.
- TO NEW EXIT SIGNS





121 Lawrence St.

Eugene OR 97401

p. 541.342.5777

f. 541.342.6128

MAN BOWN COR

12699

FYDIDES 6/30/2015

**T** 

L 3RD OREGON

P

UNIVERSITY

REVISIONS

REFERENCE

HALL


SON

Ш

DATE

ROJECT NO

DATE

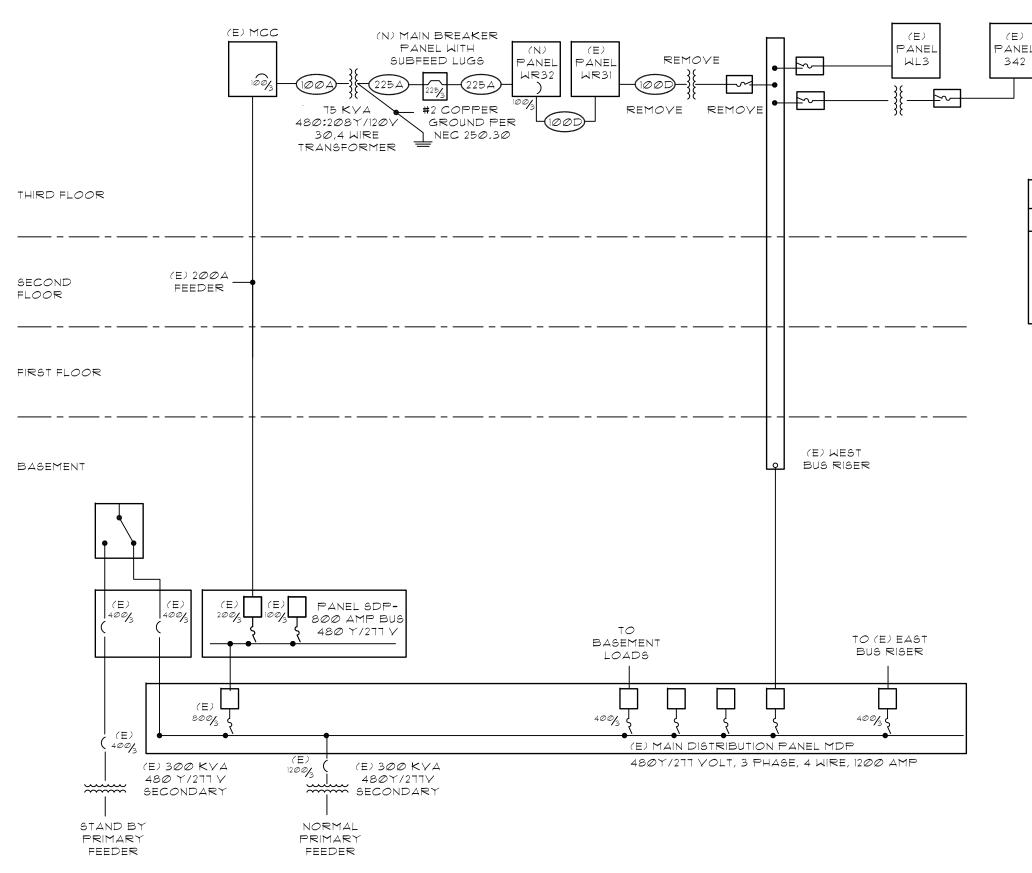

FEEDER SO	CHEDULE	
TYPE	CONDUIT	CONDUCTORS
100A	1 <b>½</b> "	3#2
100D	1 1/4"	<b>4#</b> 2
225A	2"	4 <b>#</b> ∜⊘



#### PANEL SCHEDULE

TYPE:

PHASE: 3 LOCATION: 3rd Floor West Mechanical Room

MOUNTING: Surface

PANEL: 3DP

VOLTS: 120/208

NOTES: Provide feed through lugs for Panel WR32

		D. PROJ	ATE: ECT:	August!	5, 2013
AMPS:	225	LOAD CLASS	Conn. VA	Demand Factor	Dema Load
WIRE:	4	LIGHTING	0	125%	

LOAD CLASS	VA	Factor	Load VA
LIGHTING	0	125%	0
OUTLETS	6500	•	6500
MOTOR LOADS	0	**	0
RESISTANCE LOADS	4800	100%	4800
SUBFEED	0	100%	0
WISC. LOADS	41520	100%	41520

	Connected	Demand
TOTAL VOLT-AMPS	52,820	52,820
MAXIMUM PHASE AMPS	155.7	155.7

BREA	KER			CIR.		CIR.			BREA	KER
Α	P	DESCRIPTION	WATTS	NO.	PHASE	NO.	WATTS	DESCRIPTION	P	Α
20		1 DDC Panel	500	1	A	2	2400	Water Heater	2	30
20		1 Spare		3	В	4	2400			
20	10	1 Spare		5	С	6	1500	Kitchen Receptacles	1	20
20	(1)	1 Spare		7	A	8	1500	Kitchen Receptacles	1	20
20	81	1 Spare		9	В	10	1500	Kitchen Receptacles	1	20
		Space		11	С	12	1500	Kitchen Receptacles	1	20
		Space		13	A	14		Space		
		Space		15	В	16		Space	- 107	
		Space		17	С	18		Space		
		Space		19	A	20		Space		
		Space		21	В	22		Space		
		Space		23	С	24		Space	- 3	
		Space		25	A	26		Space	18 3	
		Space		27	В	28		Space	- 2	
		Space		29	С	30		Space		
				31	A	32	14280	Panel WR32 Subfeed		
				33	В	34	14400			
		1		35	С	36	12840	Ť		
		1		37	A	38				
				39	В	40				
				41	С	42				

PHASE TOTALS Connected VA 18680 18300 15840 Demand VA 18680 15840 18300 Connected Amps 155.7 132.0 152.5 132.0 155.7 152.5

\* 10kVA at 100%, remainder at 50% \*\* 100% plus 25% of the largest Motor

: WR32		
. WITOZ	5,000,000	

VOLTS: 120/208 LOCATION: 3rd Floor West Electrical Room

MOUNTING: Flush

NOTES:

PANEL

DATE:	August 5, 2013
DPO IECT:	

LOAD CLASS	Conn. VA	Demand Factor	Demand Load VA		
LIGHTING	0	125%	0		
OUTLETS	41520	*	25760		
MOTOR LOADS	0	**	0		
RESISTANCE LOADS	0	100%	0		
SUBFEED	0	100%	0		
MISC. LOADS	0	100%	0		

	Connected	Demand
TOTAL VOLT-AMPS	41,520	25,760
MAXIMUM PHASE AMPS	120.0	74.5

BREAKER		ALC AL P & ALC SCOTE, ALC S.	NAME OF TAXABLE PARTY.	CIR.		CIR.			BREA	KER
A	P	DESCRIPTION	WATTS	NO.	PHASE	NO.	WATTS	DESCRIPTION	P	A
20	1	Office Receptacles	900	1	A	2	720	Landscape Partition	1	20
20	1	Copier / Kitchen Receptacles	1200	3	В	4	720	Landscape Partition	1	20
20	1	Copier / Kitchen Receptacles	1200	5	С	6	720	Landscape Partition	1	20
20	1	Copier / Kitchen Receptacles	1200	7	Α	8	720	Landscape Partition	1	20
20	1	Copier / Kitchen Receptacles	1200	9	В	10	720	Landscape Partition	1	20
20	1	Office Receptacles	720	11	С	12	720	Landscape Partition	1	20
20	1	Office Receptacles	720	13	A	14	720	Landscape Partition	1	20
20	1	Office Receptacles	1080	15	В	16	720	Landscape Partition	1	20
20	1	Office Receptacles	900	17	С	18	720	Landscape Partition	1	20
20	1	Office Receptacles	1080	19	A	20	720	Landscape Partition	1	20
20	1	Office Receptacles	540	21	В	22	720	Landscape Partition	1	20
20	1	Landscape Partition	720	23	С	24	720	Landscape Partition	1	20
20	1	Landscape Partition	720	23	A	26	360	Break Room Receptacles	1	20
20	1	Landscape Partition	720	23	В	28	360	Break Room Receptacles	1	20
20	1	Landscape Partition	720	23	С	30	720	Landscape Partition	1	20
20	1	Landscape Partition	720	23	Α	32	720	Landscape Partition	1	20
20	1	Landscape Partition	720	23	В	34	720	Landscape Partition	1	20
20	1	Landscape Partition	720	23	С	36		Spare	1	20
20	1	Landscape Partition	720	23	A	38	4260	Panel WR31	3	100
20	1	Landscape Partition	720	23	В	40	4260			
20	1	Spare		41	С	42	4260			

7966

66.4


PANEL SCHEDULE

PHASE TOTALS Connected VA 14280 14400 12840 Demand VA 8860 8934 107.0 Connected Amps 119.0 120.0


73.8


74.5

- 10kVA at 100%, remainder at 50%
- \*\* 100% plus 25% of the largest Motor

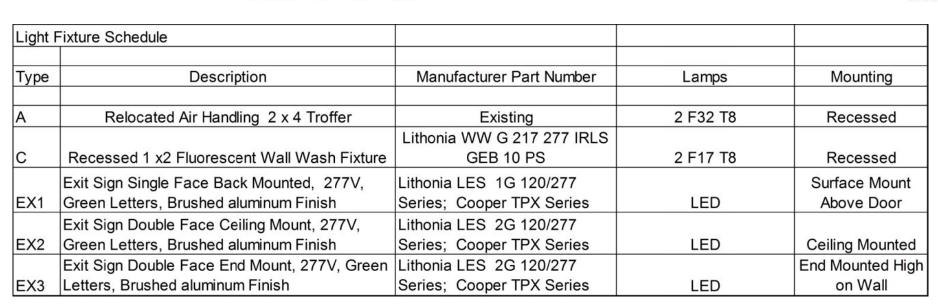



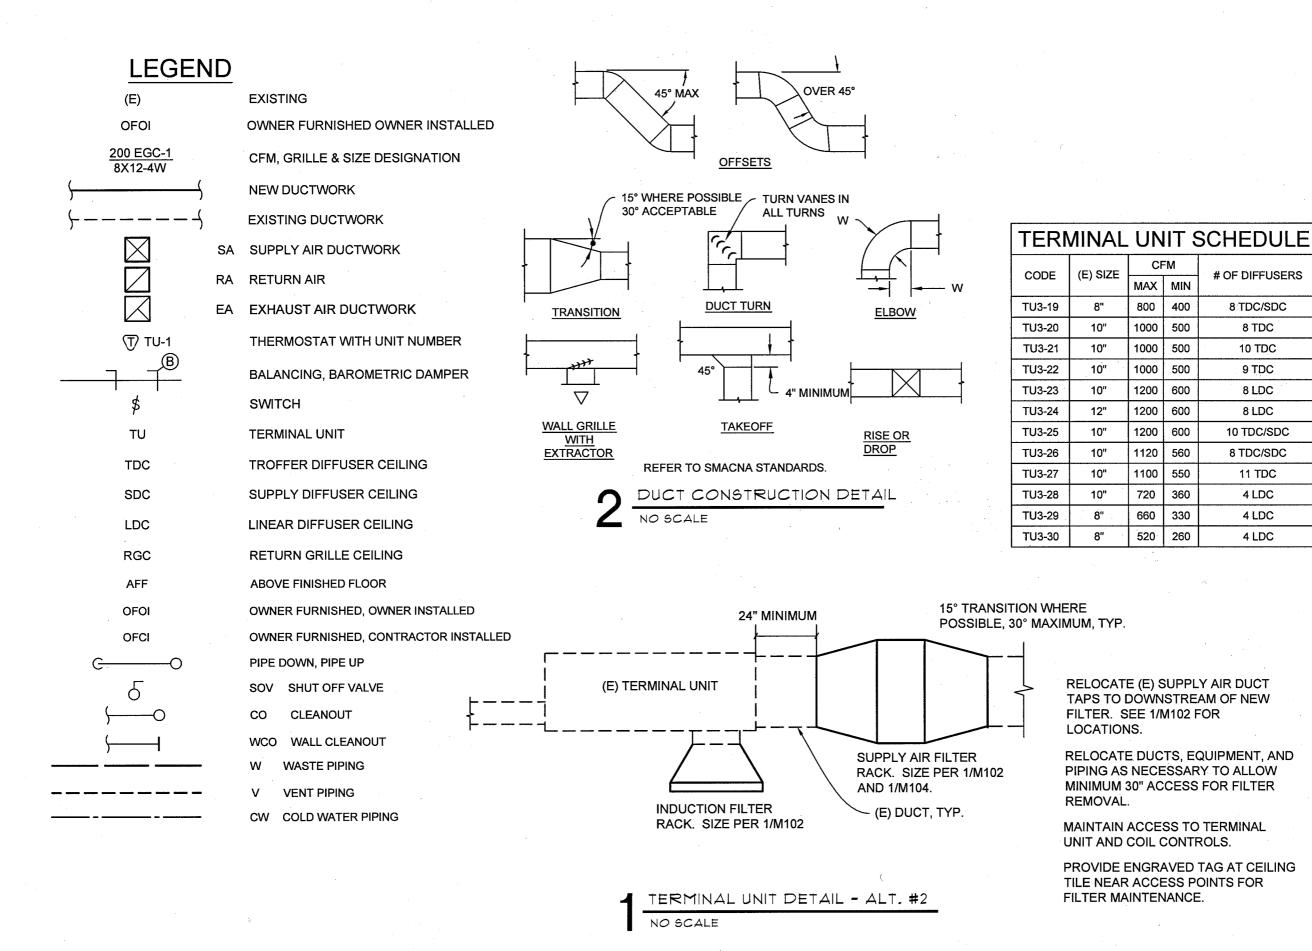

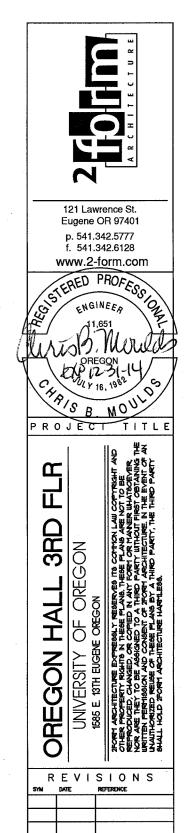

PROJECT NO.

13006

**HVAC** 

LEGEND

Ø5 AUGUST 2013

8:TDC/SDC

8 TDC

10 TDC

9 TDC

8 LDC

8 LDC

10 TDC/SDC


8 TDC/SDC


11 TDC

4 LDC

4 LDC

4 LDC

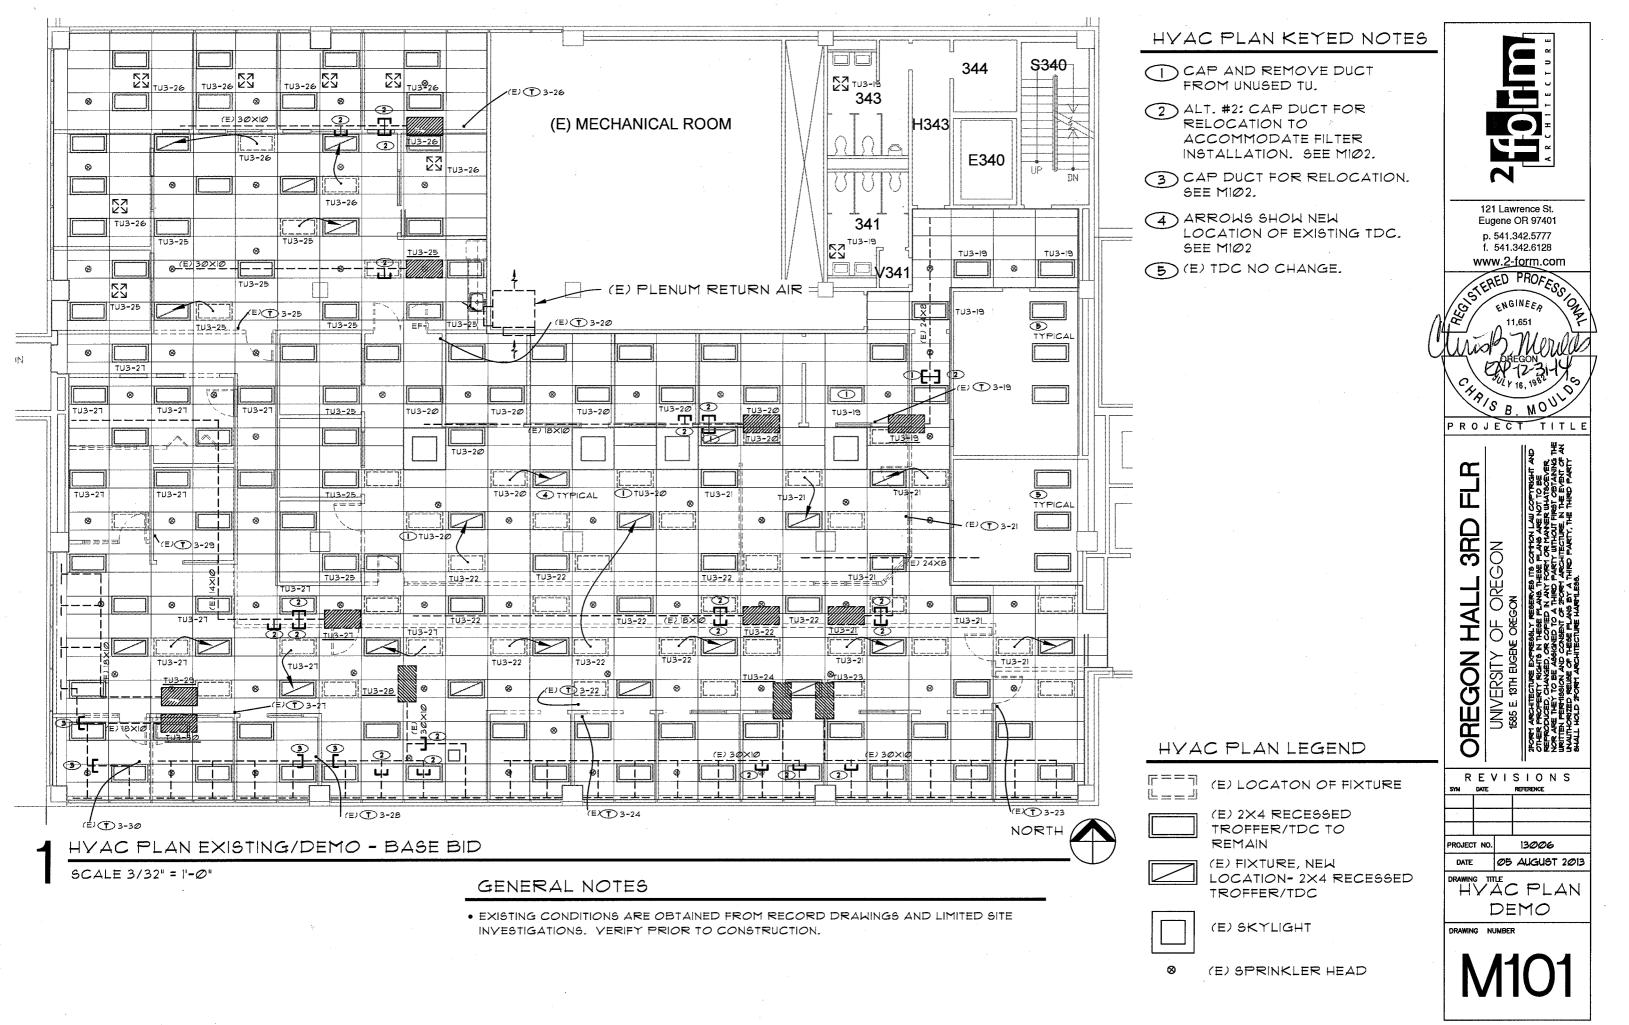

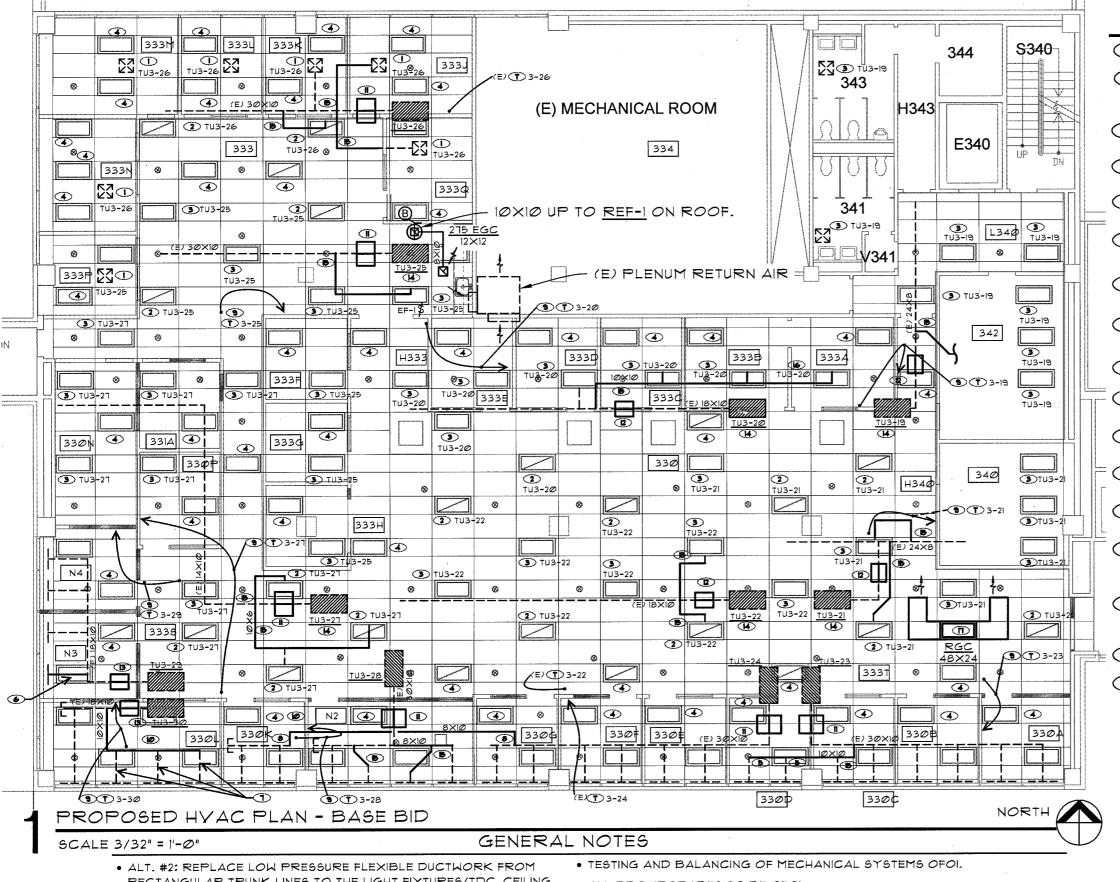

- RECTANGULAR TRUNK LINES TO THE LIGHT FIXTURES/TDC, CEILING DIFFUSERS/SDC, AND LINEAR DIFFUSERS/LDC.
- ALT, #2: REPLACE DAMAGED MEDIUM PRESSURE DUCTWORK FROM THE AIR HANDLER SUPPLY TRUNK TO THE TERMINAL UNITS. 15% OF DUCTWORK IS DAMAGED. REFER TO RECORD DRAWINGS.
- ALT. #2: REFER TO I/MODI FOR TERMINAL UNIT FILTER INSTALLATION.
- . ALT. #2: REFER TO SHEET MIØ5 FOR DUCT CLEANING

- · ALL DDC UPGRADES TO BE OFOL
- MAINTAIN MINIMUM 36" CLEARANCE ACCESS AT ALL TUS FOR CONTROLS AND FILTER ACCESS.
- REFER TO 2/MOOI FOR DUCT CONSTRUCTION DETAILS.
- REFER TO 21 13 00 FOR FIRE SPRINKLER WORK.
- CEILING TILES REMOVED FOR CONSTRUCTION SHALL HAVE ANY EXPOSED FIBERGLASS EDGES SEALED PRIOR TO RE-INSTALLATION.

## HYAC PLAN KEYED NOTES

- (I) (E) SDC TO REMAIN.
- 2 EXTEND 8" PDUCT TO RELOCATED OR (E) TDC/LIGHT FIXTURE.
- (3) (E) TDC/LIGHT FIXTURE TO REMAIN
- (4) (E) LIGHT FIXTURE WITH RA TO REMAIN.
- (5) EXTEND DUCT FROM TU3-23 TO SERVE LDC.
- (6) EXTEND DUCT FROM TU3-29 TO SERVE LDC
- (1) EXTEND DUCT FROM TU3-30 TO SERVE LDC'S.
- (8) EXTEND DUCT FROM TU3-24 TO SERVE LDCS.
- 9 RELOCATE THERMOSTAT
- (10) RELOCATE THERMOSTAT FROM CEILING TO WALL.
- (1) ALT, #2: PROVIDE FILTER BOX WITH (2) 16×20×2 SLOPED FILTERS.
- (12) ALT, #2: PROVIDE FILTER BOX WITH (1) 25×20×2 SLOPED FILTERS.
- (13) ALT, #2: PROVIDE FILTER BOX WITH (1) 20×16×2 SLOPED FILTERS.
- (14) ALT. #2: PROVIDE (1) 20×25 SLOPED FILTER ON TU INDUCTION INTAKE.
- (15) ALT. #2: RELOCATE DUCT TAPS TO ALLOW INSTALLATION OF FILTER BOX.
- (16) EXTEND DUCT FROM TU3-20.
- (17) PROVIDE 48X24X24 TALL PLENUM AT RGC AND 24X20 DUCTS WITH ENDS OPEN TO RA PLENUM.

### HYAC PLAN LEGEND

(E) LOCATON OF FIXTURE



(E) 2X4 RECESSED TROFFER/TDC TO REMAIN



(E) FIXTURE, NEW LOCATION- 2X4 RECESSED TROFFER/TDC




(E) SKYLIGHT

(E) SPRINKLER HEAD




121 Lawrence St. Eugene OR 97401 p. 541.342.5777 f. 541.342.6128 www.2-form.com

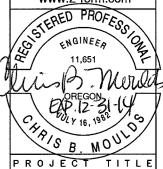

 $\alpha$ 8  $\overline{\mathbf{c}}$ **SK** HAL **8**0  $\mho$ Ш 囮

REVISIONS PROJECT NO. 13006 05 AUGUST 2013 DATE RAWING TITLE HYAC PLAN

DRAWING NUMBER

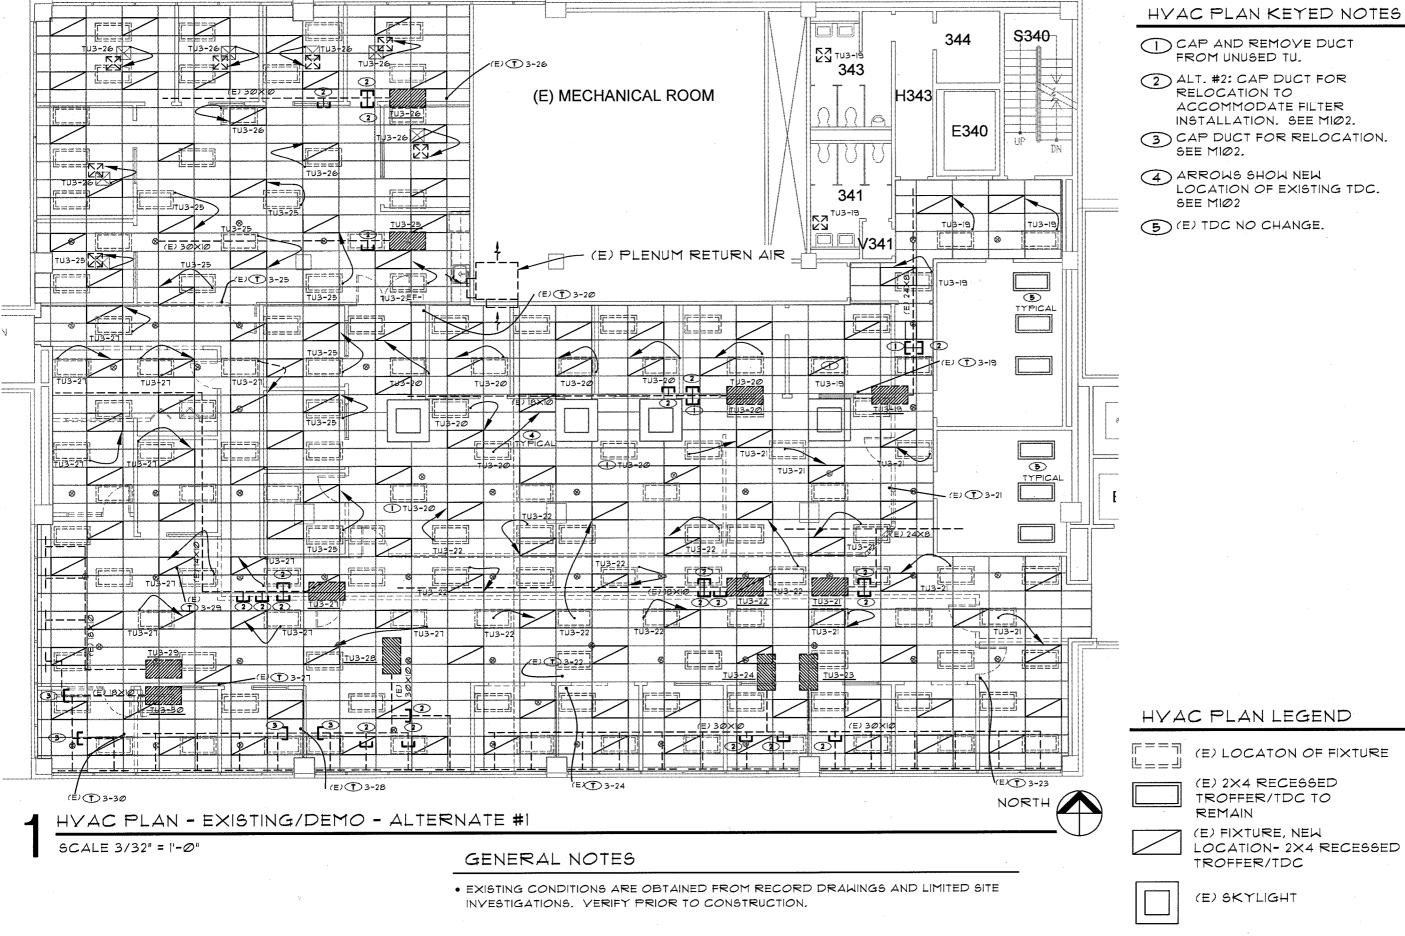

121 Lawrence St. Eugene OR 97401 p. 541.342.5777 f. 541.342.6128 www.2-form.com

STERED PROFES FRIS B. MOUL PROJECT TITLE


380  $\frac{1}{2}$ OF OREGON HAL EGON 

(E) SPRINKLER HEAD

REVISIONS PROJECT NO. 13006 05 AUGUST 2013

HYAC PLAN DEMO - ALT. #

DRAWING NUMBER

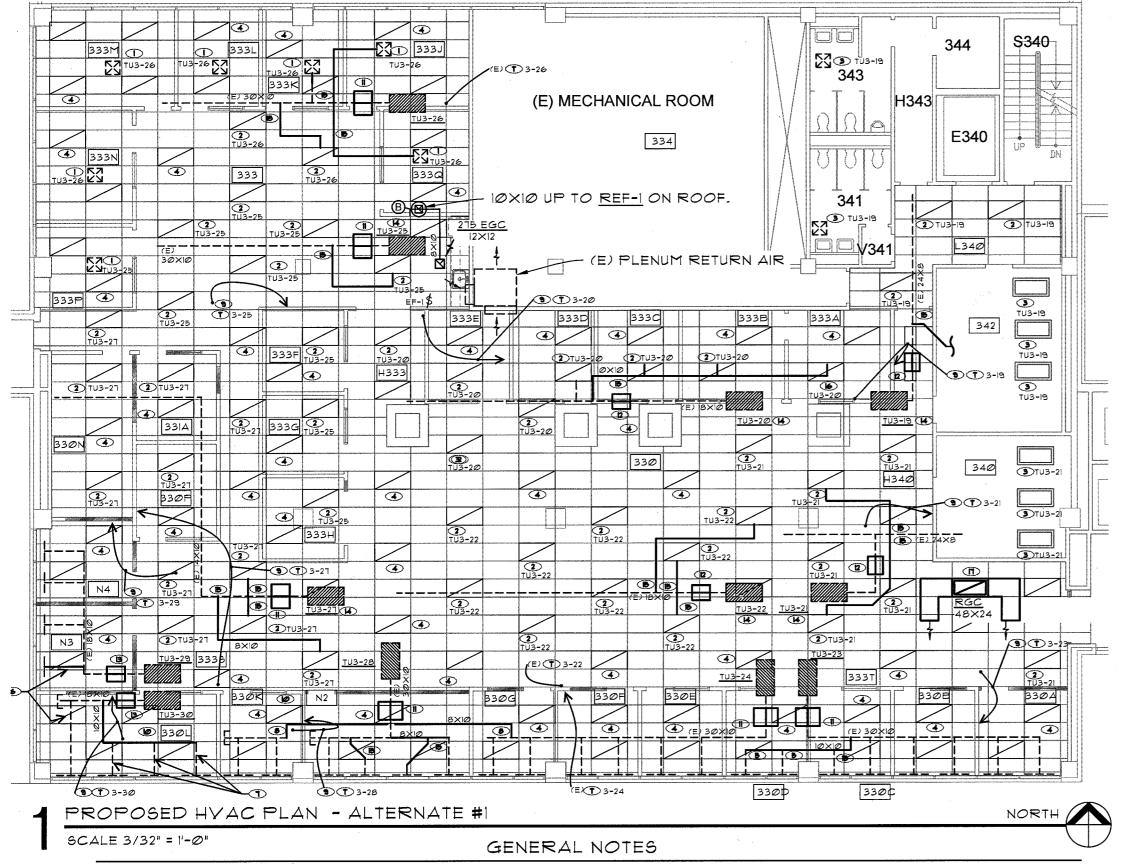

- ALT. #2: REPLACE LOW PRESSURE FLEXIBLE DUCTWORK FROM RECTANGULAR TRUNK LINES TO THE LIGHT FIXTURES/TDC, CEILING DIFFUSERS/SDC, AND LINEAR DIFFUSERS/LDC.
- ALT. #2: REPLACE DAMAGED MEDIUM PRESSURE DUCTWORK FROM THE AIR HANDLER SUPPLY TRUNK TO THE TERMINAL UNITS. 75% OF DUCTWORK IS DAMAGED, REFER TO RECORD DRAWINGS.
- ALT. #2: REFER TO I/MOO! FOR TERMINAL UNIT FILTER INSTALLATION.
- ALT, #2: REFER TO SHEET MIØ5 FOR DUCT CLEANING.

- TESTING AND BALANCING OF MECHANICAL SYSTEMS OFOL
- ALL DDC UPGRADES TO BE OFOL.
- MAINTAIN MINIMUM 36" CLEARANCE ACCESS AT ALL TUS FOR CONTROLS AND FILTER ACCESS.
- REFER TO 2/MØØI FOR DUCT CONSTRUCTION DETAILS.
- REFER TO 21 13 00 FOR FIRE SPRINKLER WORK.

## HYAC PLAN KEYED NOTES

- EXTEND (E) DUCT TO RELOCATED SDC.
- 2 EXTEND 8" P DUCT TO RELOCATED TDC/LIGHT FIXTURE.
- (E) TDC/LIGHT FIXTURE TO REMAIN
- 4 LIGHT FIXTURE WITH RA.
- (5) EXTEND DUCT FROM TU3-23.
- 6 EXTEND DUCT FROM TU3-29 TO SERVE LDC
- 1 EXTEND DUCT FROM TU3-30 TO SERVE (3) LDC'S.
- 8 EXTEND DUCT FROM TU3-24 TO SERVE (2) LDC6.
- (9) RELOCATE THERMOSTAT
- RELOCATE THERMOSTAT FROM CEILING TO WALL.
- ALT. #2: PROVIDE FILTER BOX
  WITH (2) 16×20×2 SLOPED FILTERS.
- 12) ALT. #2: PROVIDE FILTER BOX
  WITH (1) 25×20×2 SLOPED FILTERS.
- ALT. #2: PROVIDE FILTER BOX
  WITH (1) 20X16X2 SLOPED FILTERS.
- (14) ALT. #2: PROVIDE (1) 20X25 SLOPED FILTER ON TU INDUCTION INTAKE.
- (B) ALT. #2: RELOCATE DUCT TAPS TO ALLOW INSTALLATION OF FILTER BOX.
- (6) EXTEND DUCT FROM TU3-20.
- PROVIDE 48X24X24 TALL
  PLENUM AT RGC AND 24X20
  DUCTS WITH ENDS OPEN TO
  RA PLENUM.

## HYAC PLAN LEGEND

ァーー fi L \_ \_ \_ 』

(E) LOCATON OF FIXTURE



(E) 2X4 RECESSED TROFFER/TDC TO REMAIN




(E) FIXTURE, NEW LOCATION- 2X4 RECESSED TROFFER/TDC



(E) SKYLIGHT



121 Lawrence St. Eugene OR 97401 p. 541.342.5777 f. 541.342.6128 www.2-form.com

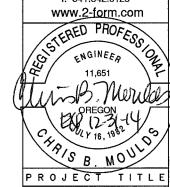

HEGON HALL 3RD FLR
UNIVERSITY OF OREGON
1685 E. 13TH EUGHE OREGON
1885 ENGLIEFER REALT REGIET AND THESE PLANS THE EVENT OF THE PROPERTY OF THE PROPERTY OF AN THIRD PARTY. THE THIRD PARTY. THE THIRD PARTY.

PROJECT NO. 13006


DATE 05 AUGUST 2013

DRAWING TITLE

HVAC

PLAN - ALT. #1

DRAWING NUMBER

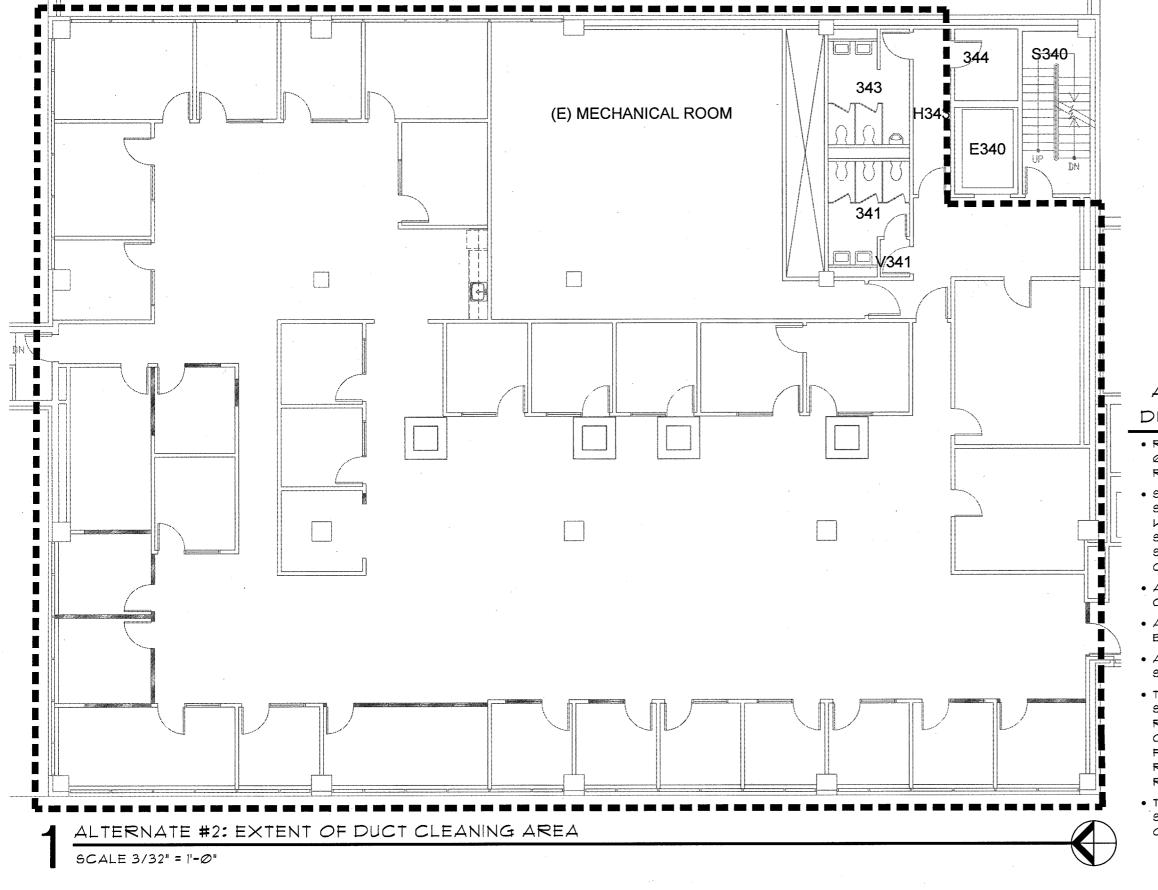

# ALTERNATE #2 DUCT CLEANING

- REFER TO SPECIFICATION SECTION 23 31
   Ø1.51 FOR DUCT CLEANING
   REQUIREMENTS.
- SUPPLY FANS AND MECHANICAL ROOM SHALL BE CLEANED INCLUDING BLOWER WHEEL, PLENUM, FILTER BANK, AND ALL SURFACES. REPLACE FILTERS (OWNER SUPPLIED) AFTER CLEANING IS COMPLETED.
- ALL EXISTING DUCTWORK SHALL BE CLEANED.
- ALL TERMINAL UNITS AND COILS SHALL BE CLEANED.
- ALL EXISTING LIGHT FIXTURE TROFFERS SHALL BE CLEANED.
- THE PLENUM SIDE OF ALL CEILING TILES SHALL BE YACUUMED CLEAN. TILES REMOVED FOR CONSTRUCTION OR CLEANING SHALL HAVE ANY EXPOSED FIBERGLASS EDGES SEALED PRIOR TO RE-INSTALLATION. THIS IS NOT REQUIRED UNDER ALTERNATE # .1
- TESTING AND BALANCING OF CLEANED SYSTEMS WILL BE PROVIDED BY OWNER



PROJECT NO. 13006


DATE 05 AUGUST 2013

DRAWING TITLE

ALT #2 - DUCT

CLEANING DRAWING NUMBER

	PLUMBING FIXTURE SCHEDULE										
CODE	0005		CONNEC	CTIONS		MANUFACTURER & MODEL	REMARKS				
CODE	FIXTURE	W	٧	HW	CW		KLIMAKKS				
P-1A	KITCHEN SINK ADA	2	1-1/2	1/2	1/2	REFER TO ARCHITECTURAL	PROVIDE INSULATION KIT. ADA INSTALLATION				
P-2	WATER HEATER				3/8	EEMAX MT005240T	ELECTRIC TANKLESS 4.8 KW AT 240 VOLT. 0.3 GALLON TURN ON. FACTORY SET AT 105°F. MINIMUM 0.93 EF PER OEESC				

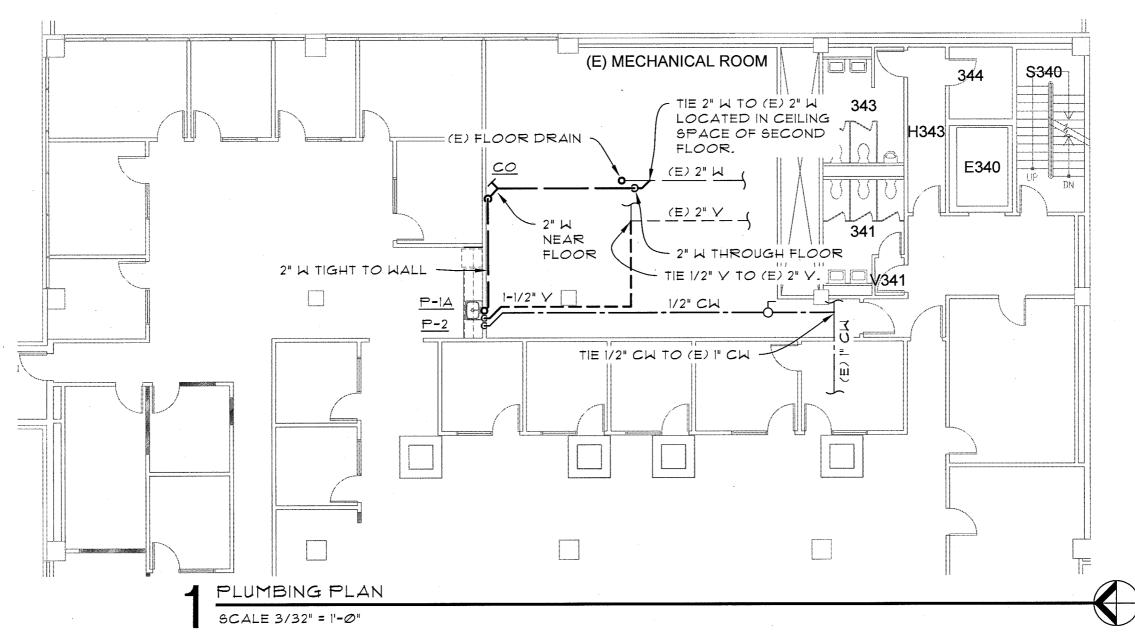


## GENERAL NOTES

- CAULK AND SEAL MECHANICAL ROOM WALL AND FLOOR PENETRATION AIRTIGHT.
- EXISTING CONDITIONS ARE OBTAINED FROM RECORD DRAWINGS AND LIMITED SITE INVESTIGATIONS. VERIFY PRIOR TO CONSTRUCTION.



121 Lawrence St. Eugene OR 97401 p. 541.342.5777 f. 541.342.6128 www.<u>2-for</u>m.com

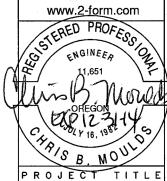

OREGON HALL 3RD FLR

UNIVERSITY OF OREGON
1685 E. 13TH EUGENE OREGON
1686 E. 13TH EUGENE OR OFFICIAL AND COPPRICHT AND
1686 PROPERTY RIGHTS IN THESE PLANS, THESE PLANS ARE IN TO BE THE PROPERTY BENEFICED TO A THIRD PARTY WITHOUT PROPERTY AND THE PROPERTY AND THE PROPERTY AND THE PROPERTY AND THE PROPERTY AND PARTY AND PARTY

						11					
SYM	R	E	-	-	S		-	N	S		
					L					_	
		_			1						
					Т,	12.	20	_			
PRO	PROJECT NO.			13006							
DATE				Ø5 AUGUST 201							
DRA					4	E	3 1	70	<b>=</b>		

PLAN
DRAWING NUMBER

# FOR REFERENCE ONLY



MECHANICAL, ELECTRICAL, CIVIL CONSULTANTS 975 LINCOLN ST. / EUGENE OR 97401 (540 696-8478 / (540 345-5303 FAX PO. BOX 10347 / EUGENE OR 97440

ird floor plan

university of oregon oregon Hall energy conservation measures

DATE

RECORD DRAWING

4/10/95

DESIGNER N/

> PROJECT 893793

FILENAME 89373m4.dwg

SHEET NO

