

CONTACT INFORMATION:

<u>BUILDING OWNER</u> UNIVERSITY OF OREGON CONTACT: GEORGE BLEEKMAN 1295 FRANKLIN BLVD. EUGENE, OREGON 97403-1276 PHONE: (541) 346-2625 E-MAIL: bleekman@uoregon.edu

ENGINEERING EVERGREEN ENGINEERING CONTACT: PATRICK SANDOW 1740 WILLOW CREEK CIRCLE EUGENE, OREGON 97402 PHONE: (541) 484-4771 E-MAIL: psandow@eeeug.com

227FT²

106FT²

104

110FT²

ELECT 131 < 62FT²

133 108FT²

100C 98FT²

193FT²

105

H100 607FT²

//ELEVATOR/

S130 40FT²

122 207FT²

V100 155FT²

ELEVATOR EQUIP RM 130 104FT²

122A 42FT²

FIRST FLOOR PLAN

1/8"=1'-0"

106 164FT²

108

105 & 108 COMBINED 500FT²

123 108FT²

161FT²

110 51FT²

H100

121 239FT²

120 240FT²

109 111FT²

112

S120 101FT²

204FT²

115

ENVIRONMENTAL HEALTH AND SAFETY UNIVERSITY OF OREGON FIRE SYSTEM MANAGER CONTACT: DREW STANDRIDGE 1318 FRANKLIN BLVD.

EUGENE, OR 97403-5224 PHONE: (541) 346-2849 E-MAIL: des@uoregon.edu

<u>BUILDING LOCATION</u> RAINIER BUILDING 1244 WALNUT ST. EUGENE, OR 97403

KEYED NOTES:

- 1) POINT OF CONNECTION TO NEW 4" WATER SERVICE INSTALLED UNDER SEPARATE CONTRACT.
- 2 CONTROL VALVE ASSEMBLIES LOCATED IN STORAGE CLOSET 115 SERVING THE WET SYSTEMS ON 1ST AND 2ND FLOORS, AND DRY SYSTEM IN THE ATTIC.
- (3) FIRE RISERS TO 2ND FLOOR AND ATTIC.
- 4) EXISTING FIRE ALARM PANEL, HONEYWELL NOTIFIER #NFW2-100. FIRE SPRINKLER CONTRACTOR TO PROVIDE CONNECTION TO EXISTING PANEL FOR FIRE VALVE MONITORING.
- (5) EXISTING DOMESTIC WATER SERVICE TO REMAIN.

CODE SUMMARY:

BUILDING STORIES:

OCCUPANCY TYPE:

CONSTRUCTION TYPE: BUILDING AREA:

1ST FLOOR 5,804 FT² 2ND FLOOR 5,888 FT² TOTAL 11,692 FT²

FLOW TEST DATA:


HYDRANT #92023 AT THE CORNER OF FRANKLIN BLVD & WALNUT ST, APPROXIMATELY 160' SOUTH OF RAINIER BUILDING.

STATIC PRESSURE: 70.0 PSI

RESIDUAL PRESSURE: 56.0 PSI


QUANTITY FLOWING: 2,738.0 GPM FLOW AT 20 PSI: 5,460 GPM

DATE OF TEST: 9/18/07

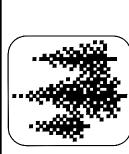

| RE SPRIN | RE SPRINKLER SYSTEM | EM | œ | MINIER | RAINIER BUILDING | | |
|----------------|---------------------|------------------------|---|-------------|---------------------|--|--|
| RST FLO | RST FLOOR PLAN | | LOCATION: 1 | 244 W | ALNUT S | rreet, eugen | LOCATION: 1244 WALNUT STREET, EUGENE, OR 97403 |
| | 10B #: | JOB #: CLIENT REF #: | DESIGN: PLS DRAWN: ISK | DRAWN: | | CHECK: | APPD: |
| 01 | 2684.0.01 | | SCALE: NOTED | DATE: | DATE: 5/20/13 DATE: | DATE: | DATE: |
| IG, DESIGN AND | PERTINENT SPECIF | ICATION, IS INTENDED S | SOLELY FOR THE PRO- ROBFEN ENGINEERING | SUECT STATE | D IN THE TITLE | IG, DESIGN AND PERTINENT SPECIFICATION, IS INTENDED SOLELY FOR THE PROJECT STATED IN THE TITLE BLOCK. IT MAY NOT BE SUITABLE OR SAFE SET OF THIS DRAWING WITHOUT WRITTEN CONSENT OF EXPRESENT FINGUIFFERING IS PROHIBITED. | SUITABLE OR SAFE |

ISSUED FOR BID

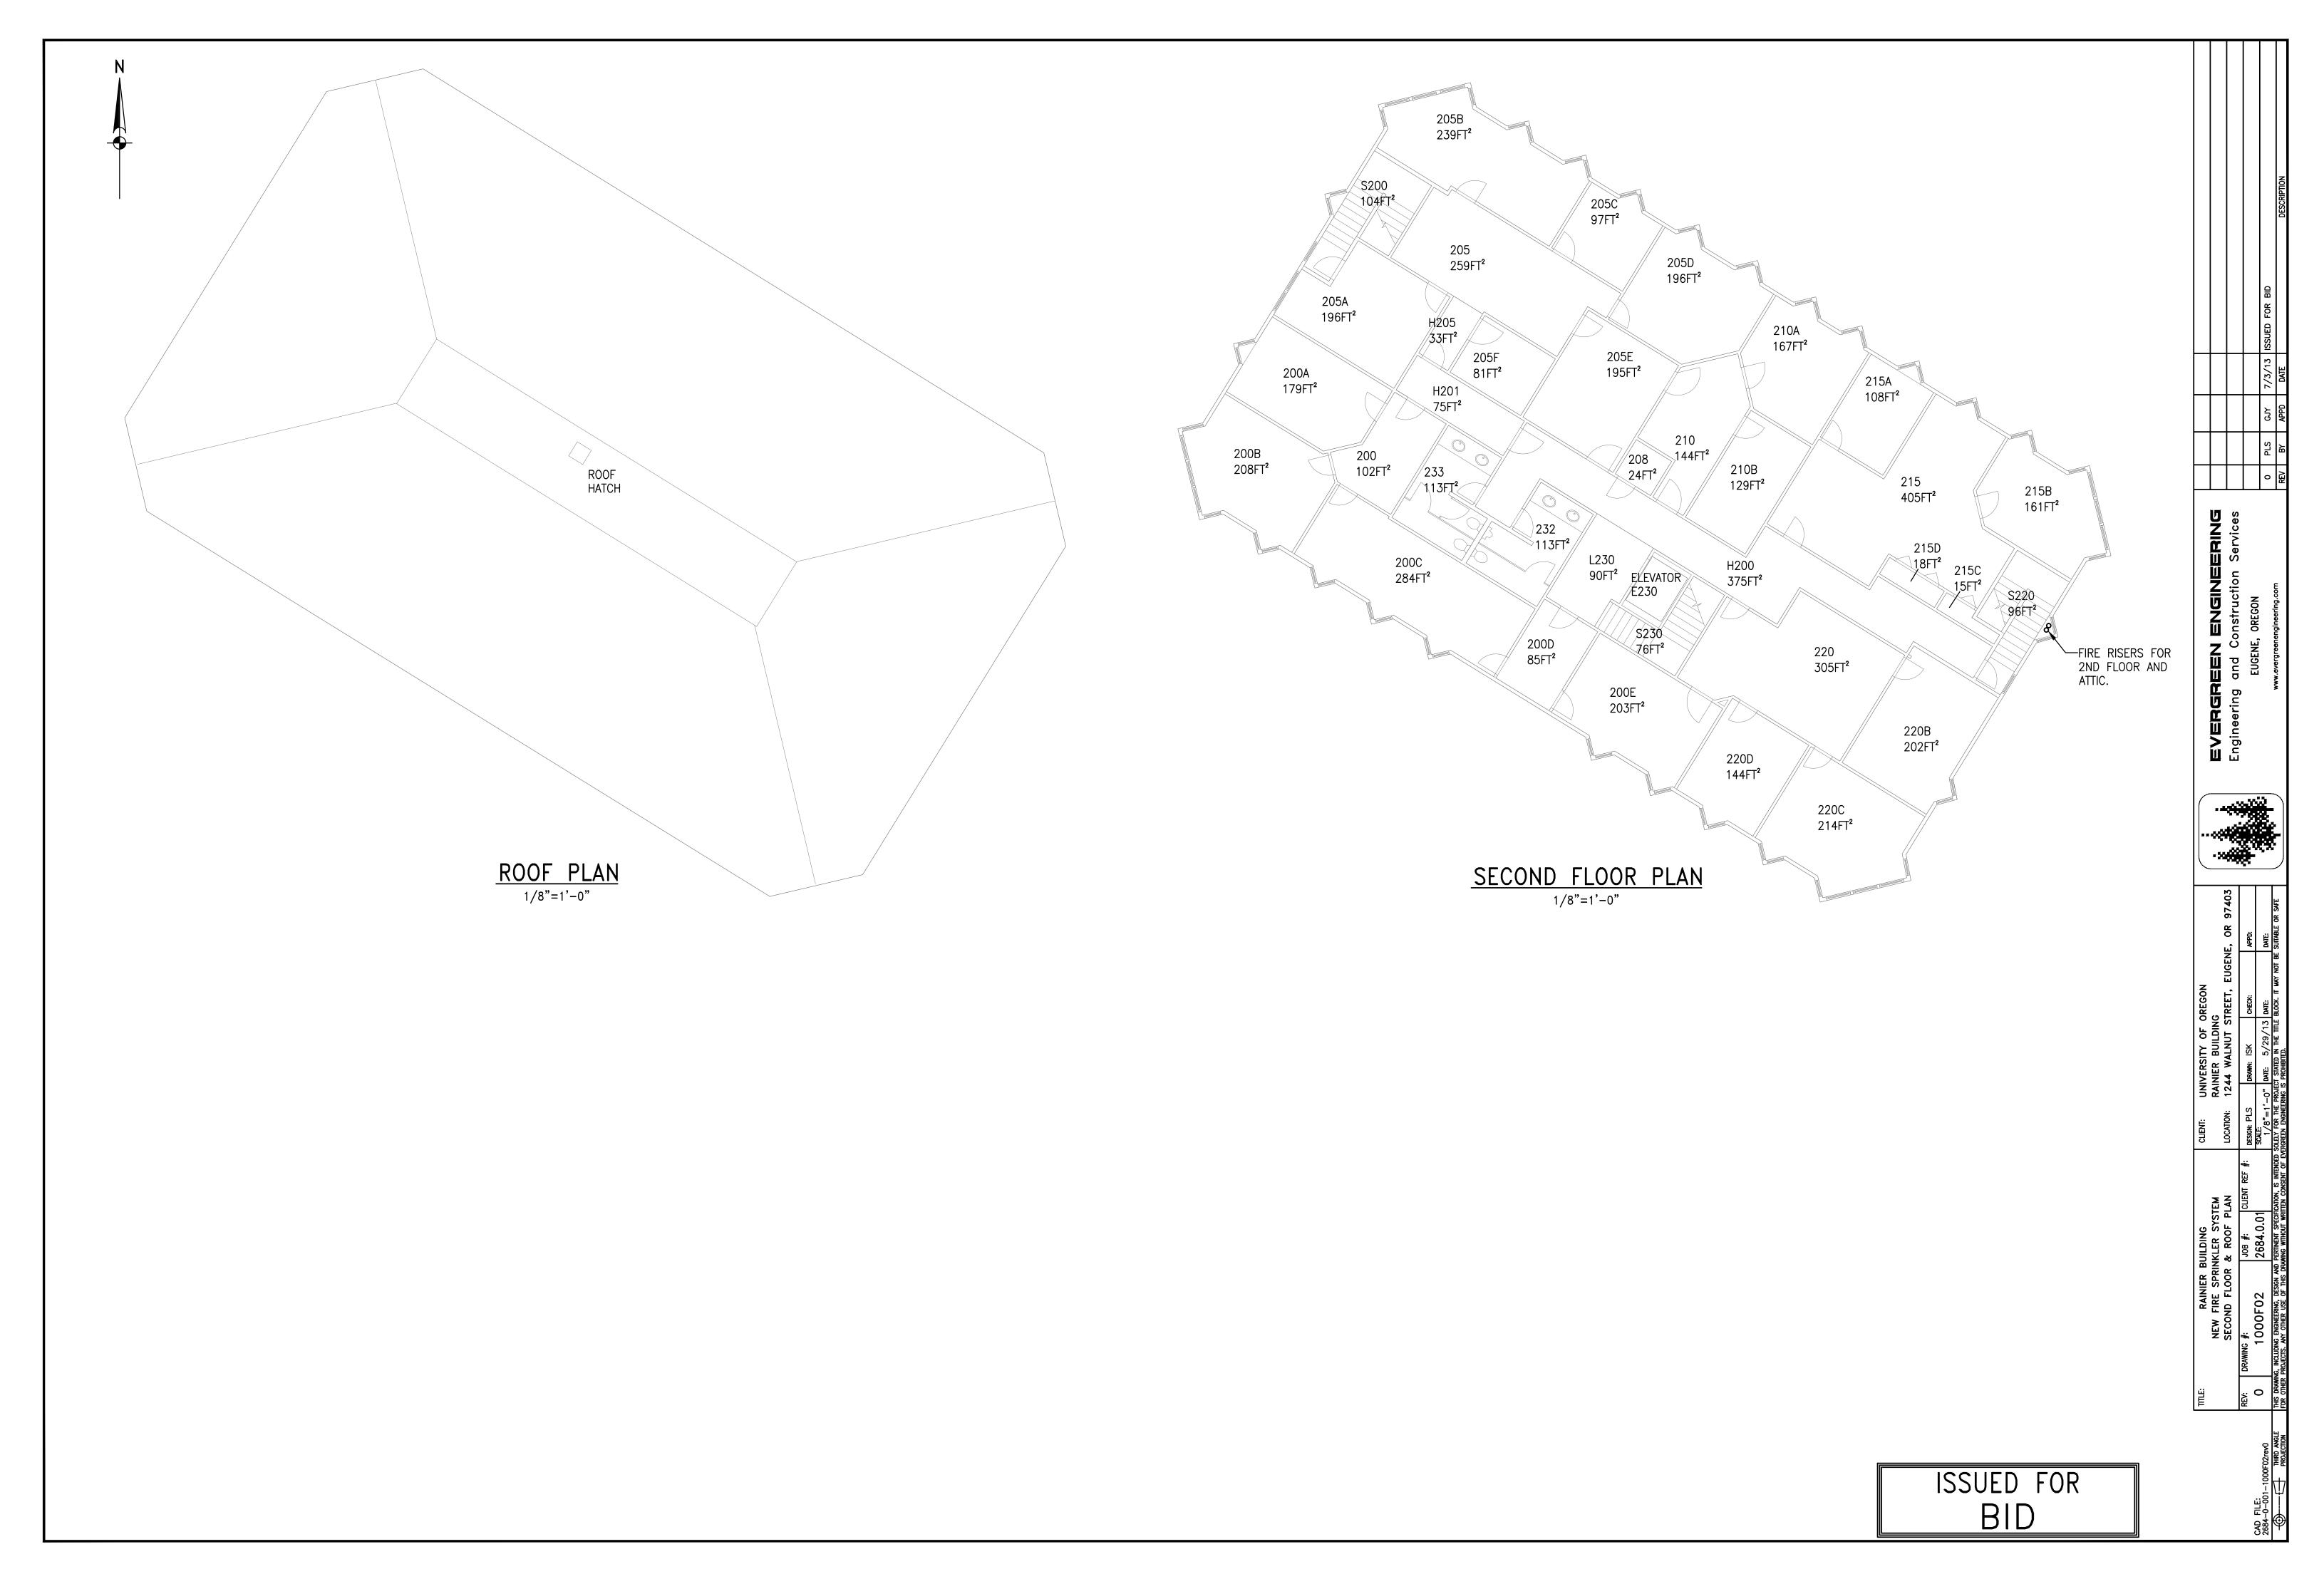

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106 109 112 110 123 120 121

PARTIAL SITE PLAN

1/8"=1'-0"

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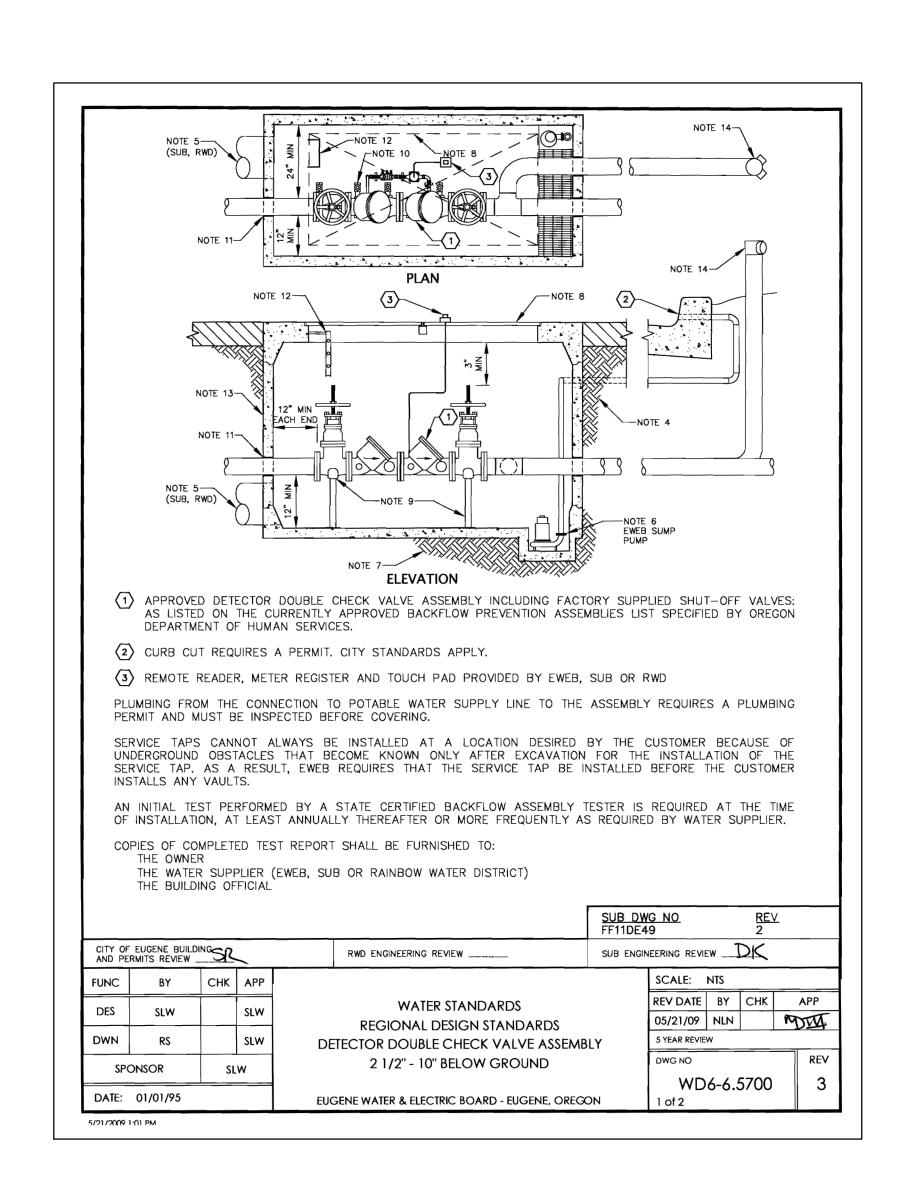
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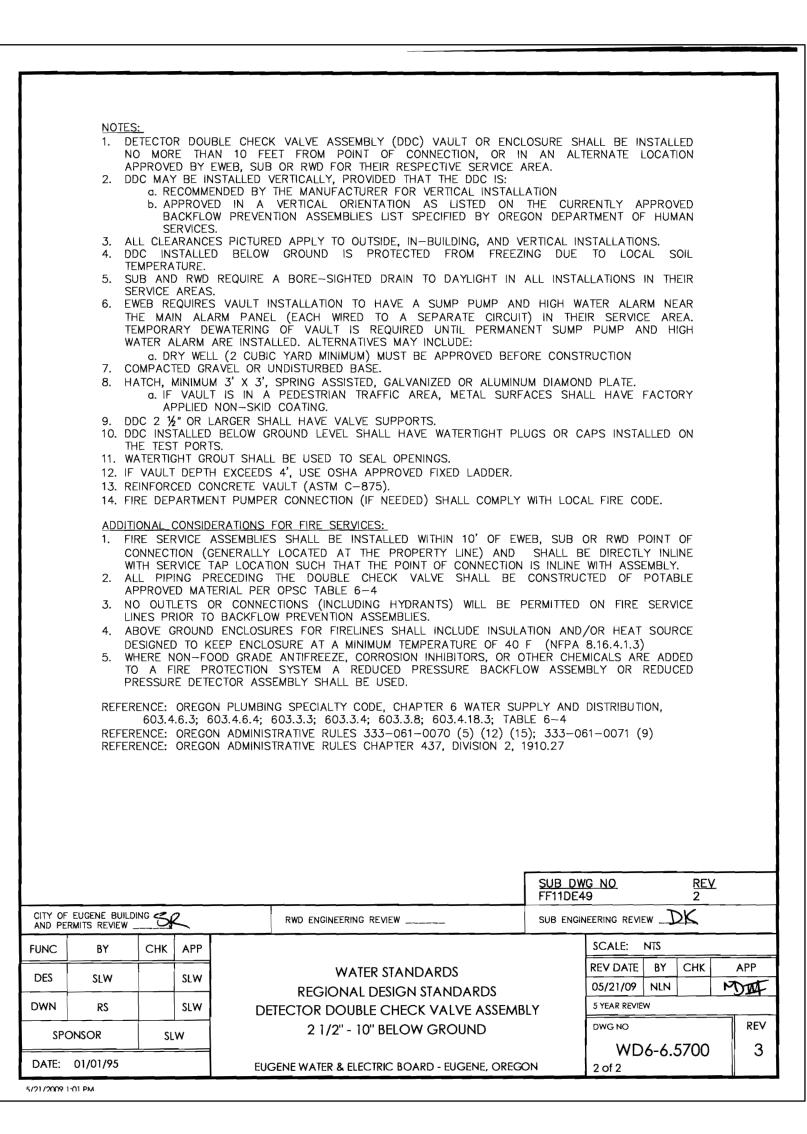
GENERAL NOTES:


- A. ALL CONSTRUCTION AND MATERIALS SHALL CONFORM TO THESE PLANS. THE PROJECT SPECIFICATIONS, AND THE APPLICABLE REQUIREMENTS OF THE CURRENT EDITION OF THE CITY OF EUGENE STANDARD CONSTRUCTION
- ALL WORK SHALL COMPLY WITH ALL LOCAL JURISDICTION CODES, STANDARDS, ORDINANCES AND REQUIREMENTS. ATTENTION EXCAVATORS: OREGON LAW REQUIRES YOU TO FOLLOW RULES ADOPTED BY THE OREGON UTILITY NOTIFICATION CENTER. THOSE RULES ARE SET FORTH IN OAR 952-001-0010 THROUGH OAR 952-001-0090 YOU MUST NOTIFY THE CENTER AT LEAST 2 BUSINESS DAY, BUT NOT MORE THAN 10 BUSINESS DAYS, BEFORE COMMENCING AN EXCAVATION. CALL 503-246-6699 OR 1-800-332-2344.
- D. THE CONTRACTOR SHALL PROVIDE PROTECTION NECESSARY TO PREVENT DAMAGE TO EXISTING IMPROVEMENTS TO REMAIN. THE CONTRACTOR SHALL RESTORE ALL DAMAGED OR DISTURBED AREAS TO THEIR ORIGINAL CONDITION OR BETTER. UNLESS NOTED OTHERWISE.
- E. PROTECT ALL ITEMS ON ADJACENT PROPERTIES AND IN THE RIGHT-OF-WAY INCLUDING BUT NOT LIMITED TO SIGNAL EQUIPMENT, PARKING METERS, SIDEWALKS, STREET TREES, CURBS, PAVEMENT AND SIGNS. CONTRACTOR SHALL BE RESPONSIBLE FOR RESTORING ANY DAMAGED ITEMS TO ORIGINAL CONDITION.
- F. PROTECT STRUCTURES, UTILITIES, SIDEWALKS AND OTHER FACILITIES IMMEDIATELY ADJACENT TO EXCAVATIONS, FROM DAMAGES CAUSED BY SETTLEMENT, LATERAL MOVEMENT, UNDERMINING, WASHOUT AND OTHER HAZARDS. G. REMOVE ALL MATERIALS EXCAVATED FROM WORK AND DISPOSE AT A PROPER LANDFILL.
- H. ALL REQUIRED SHORING NECESSARY FOR THE CONSTRUCTION OF THE VAULTS, STRUCTURES AND TRENCHES SHALL BE DESIGNED, PERMITTED AND PROVIDED BY THE CONTRACTOR.
- . ALL PUBLIC WATER SYSTEM WORK TO BE CONSTRUCTED BY EWEB UNDER SEPARATE PERMIT. CONTRACTOR TO SCHEDULE AND COORDINATE NEW WATER SYSTEM WORK WITH EWEB PRIOR TO CONSTRUCTION. EWEB REQUIRES 3-4 WEEKS LEAD TIME FOR SCHEDULING. CONTACT CHRIS BIGELOW, 541-685-7353.

KEYED NOTES:

- 1) NEW 4" WATER SERVICE CONNECTION POINT AT PROPERTY LINE WITH APPROXIMATELY 4'-0" OF COVER.
- 2 NEW UNDERGROUND VAULT AND DOUBLE CHECK DETECTOR ASSEMBLY (FEBCO OR CONBRACO), BY SITE CONTRACTOR, TO COMPLY WITH EWEB STANDARDS AND APPROVED BY USC FOUNDATION FOR CROSS CONNECTION CONTROL. CONTRACTOR TO REMOVE AND REPLACE LANDSCAPING AS REQUIRED. COORDINATE WITH OWNER.
- 3 NEW 4" WATER SERVICE UNDER BUILDING FOUNDATION AND TURNED UP INTO STORAGE CLOSET WITH BLIND FLANGE. INSULATE PIPE IN CRAWL SPACE WITH 1-1/2" FIBERGLASS INSULATION AND PVC OR ALUMINUM JACKETING.
- (4) FIRE DEPARTMENT CONNECTION TO CONFORM TO OREGON FIRE CODE, NFPA 13 AND U.O. STANDARDS.





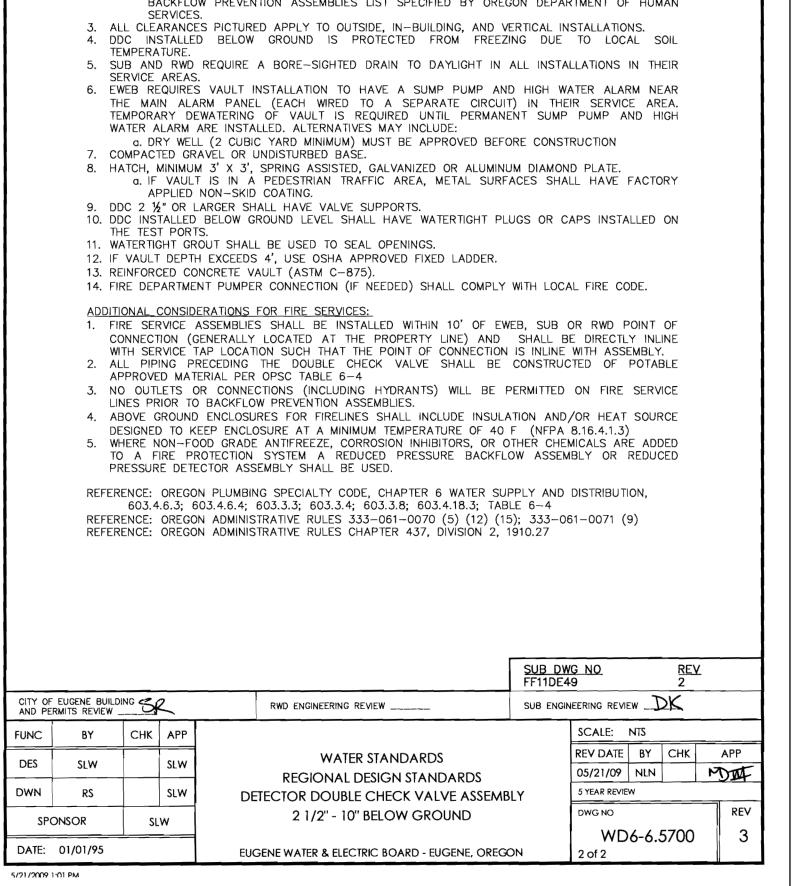

REFERENCE ONLY

