

PROJECT INFORMATION

BUILDING OWNER:
 UNIVERSITY OF OREGON
CONTACT: GLEN MACDONALD, PROJECT MANAGER
 CAMPUS OPERATIONS
 1276 UNIVERSITY OF OREGON
 EUGENE, OR 97403-1276
 PH: (541) 346-2281 FAX: (541) 346-6927
 glenm@uoregon.edu

PROJECT ARCHITECT:
 UNIVERSITY OF OREGON
CONTACT: KEVIN SPAHN
 CAMPUS OPERATIONS
 1276 UNIVERSITY OF OREGON
 EUGENE, OR 97403-1276
 PH: (541) 346-8238 FAX: (541) 346-6927
 spahn@uoregon.edu


PROJECT DESCRIPTION

SCOPE OF WORK:
 SUMMARY: REMODEL SUITE/ROOMS 141, 142 & 143 INCLUDING NEW INTERIOR WALLS, DOORS AND FRAMES, NEW CARPET, NEW ACOUSTIC CEILING TILE IN EXISTING CEILING GRID AND MINOR NEW CEILING WORK, NEW LIGHT FIXTURES AND SUPPLY / RETURN GRILLS

ABATEMENT:
 ANY NECESSARY ABATEMENT OF HAZARDOUS MATERIALS IN THE AFFECTED SPACES TO BE COMPLETED BY OWNER PRIOR TO THE COMMENCEMENT OF THIS PROJECT


MEP SCOPE NOTE:
 DRAWINGS SHOW DESIGN INTENT FOR REMODELED PLUMBING, MECHANICAL, AND ELECTRICAL SYSTEMS. ANY ADDITIONAL DRAWINGS, CALCULATIONS, OR DOCUMENTATION REQUIRED FOR PLUMBING, MECHANICAL, OR ELECTRICAL PERMITS TO BE DESIGN BUILD BY SUB-CONTRACTORS.

CODE SUMMARY:
 - OCCUPANCY TYPE "B", EDUCATION ABOVE 12TH GRADE
 - OCCUPANCY SEPARATION: NONE REQUIRED
 - CONSTRUCTION TYPE V

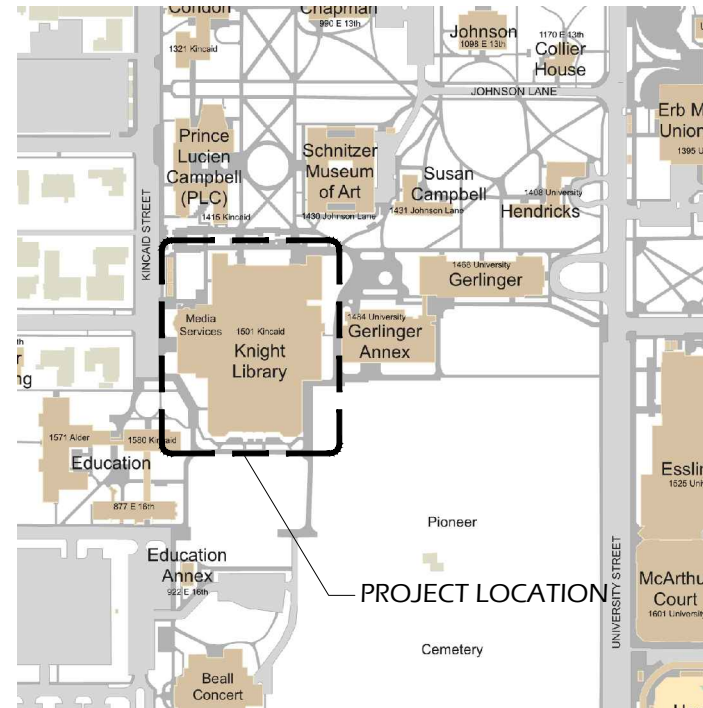


VICINITY MAP

Scale: NTS

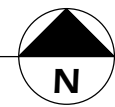


SITE INFORMATION:

ADDRESS: KNIGHT LIBRARY
 1501 KINCAID STREET
PROJECT AREA: 3197 SF
BUILDING FOOTPRINT AREA: 103210 SF

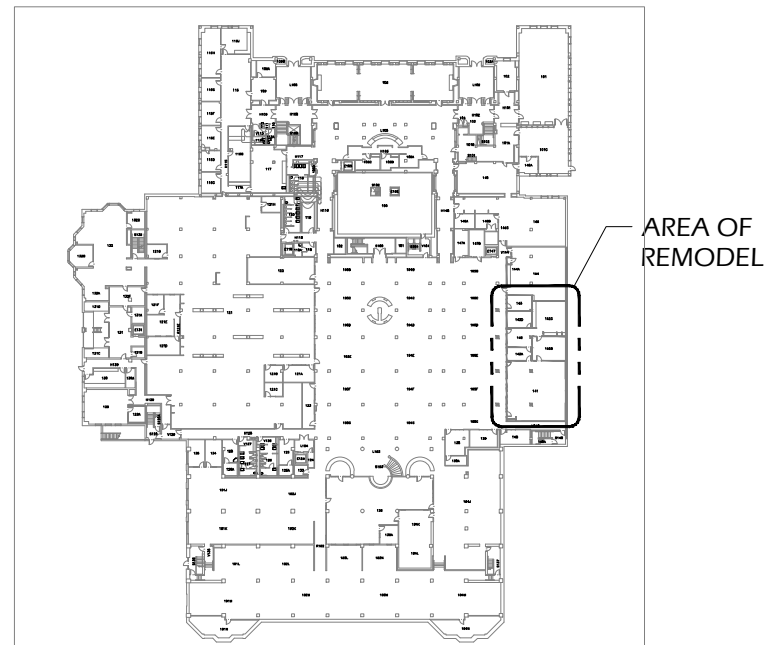

KEY PLAN - 1ST FLOOR

Scale: NTS

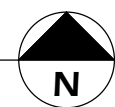

GENERAL NOTES:

1. ALL WORK SHALL COMPLY WITH LOCAL CODES, OREGON STATE CODES, AMENDMENTS, RULES, REGULATIONS, ORDINANCES, LAWS, ORDERS, APPROVALS, ETC. THAT ARE REQUIRED BY GOVERNING AUTHORITIES. IN THE EVENT OF CONFLICT, THE MOST STRINGENT REQUIREMENTS SHALL APPLY. REQUIREMENTS INCLUDE, BUT ARE NOT LIMITED TO, THE CURRENTLY APPLICABLE EDITIONS OR PUBLICATIONS OF THE FOLLOWING:
 1. 2010 EDITION OSSC
 2. OREGON ADMINISTRATIVE CODE
 3. NATIONAL FIRE PROTECTION ASSOCIATION
 4. STATE OF OREGON 2011 ELECTRICAL SPECIALTY CODE
 5. STATE OF OREGON 2011 PLUMBING SPECIALTY CODE
 6. STATE OF OREGON 2010 MECHANICAL SPECIALTY CODE
 7. STATE OF OREGON 2010 FIRE CODE
2. CONTRACTOR SHALL EXAMINE AND VERIFY CONDITIONS OF THE JOB SITE. ANY DISCREPANCY BETWEEN DRAWINGS AND EXISTING CONDITIONS SHOULD BE RECORDED IN WRITING AND REPORTED TO THE ARCHITECT FOR RESOLUTION PRIOR TO COMMENCEMENT OF WORK.
3. ALL DIMENSIONS NOTED IN FLOOR PLANS AND SECTIONS ARE TO FINISH UNLESS NOTED OTHERWISE. NOTIFY ARCHITECT OF ANY DISCREPANCIES OR CONFLICT PRIOR TO SUBSEQUENT WORK. DO NOT SCALE DRAWINGS.
5. MATERIAL CHOICES, FIXTURES, ADHESIVES, AND FINISHES NOT SPECIFIED SHALL BE PRE-APPROVED BY OWNER AND ARCHITECT.
6. ALL CHANGE ORDERS SHALL BE WRITTEN AND SHALL BE APPROVED BY ARCHITECT AND OWNER PRIOR TO EXECUTION OF WORK.
7. WOOD IN CONTACT WITH CEMENT OR MASONRY SHALL BE PRESSURE TREATED.
8. PROVIDE ACCESS TO CONCEALED VALVES, DAMPERS, CONTROLS, ELECTRONIC JUNCTION BOXES, ETC. OBTAIN ARCHITECTS APPROVAL IN LOCATING ACCESS DOORS PRIOR TO INSTALLING.
9. PIPING, CONDUIT, ROUGH-IN AND SIMILAR WORK SHALL BE CONCEALED UNLESS NOTED OTHERWISE.
10. SITE TO BE BROOM CLEANED AT END OF WORK DAY.

DRAWING INDEX

- | | |
|------|--|
| G001 | COVER, VICINITY MAP, INDEX |
| G002 | CODE ANALYSIS - EXISTING/PROPOSED LAYOUT |
| G003 | CODE ANALYSIS |
| A001 | DEMOLITION FLOOR PLAN |
| A002 | DEMOLITION REFLECTED CEILING PLAN |
| A003 | DEMOLITION REFLECTED CEILING PLAN - ALTERNATE 1 |
| A101 | NEW WORK FLOOR PLAN |
| A102 | NEW WORK REFLECTED CEILING PLAN |
| A103 | NEW WORK REFLECTED CEILING PLAN - ALTERNATE 1 |
| A301 | INTERIOR ELEVATIONS |
| A401 | DETAIL |
| A501 | ROOM FINISH SCHEDULE |
| A502 | DOOR AND WINDOW SCHEDULES |
| A601 | FURNITURE PLAN - CONTRACTOR |
| E001 | DEMOLITION ELECTRICAL PLAN |
| E002 | DEMOLITION ELECTRICAL REFLECTED CEILING PLAN |
| E003 | DEMOLITION ELECTRICAL REFLECTED CEILING PLAN - ALTERNATE 1 |
| E101 | NEW WORK ELECTRICAL PLAN |
| E102 | NEW WORK ELECTRICAL REFLECTED CEILING PLAN |
| E103 | NEW WORK ELECTRICAL REFLECTED CEILING PLAN - ALTERNATE 1 |
| M001 | DEMOLITION MECHANICAL PLAN |
| M101 | NEW WORK MECHANICAL PLAN |

ISSUED FOR BIDDING

General Notes		
△	XXX	xx/xx/13
No.	Revision/Issue	Date



TITLE SHEET

UNIVERSITY OF OREGON

DESIGN SERVICES GROUP
 1295 FRANKLIN BOULEVARD
 EUGENE, OREGON 97403-1276
 (541) 346-2270

FACILITIES SERVICES
 1276 UNIVERSITY OF OREGON
 EUGENE, OREGON 97403-1276

PROJECT NAME:
 KNIGHT LIBRARY
 1ST FLOOR
 THE DIGITAL
 SCHOLARSHIP CTR

PROJECT NO.:
 WK224612

DATE:
 06/12/2013

DESIGN/DRAWN BY:
 KS/MNL

SCALE:
 AS NOTED

DRAWING NO.:
G001

CODE SUMMARY

BUILDING OCCUPANCY

B - EDUCATION ABOVE THE 12TH GRADE (304.1)

CONSTRUCTION TYPE

7

AUTOMATIC SPRINKLER SYSTEM

FULLY SPRINKLERED

OSSC 2010 CODE ANALYSIS INFORMATION

CHAPTER 5 - GENERAL BUILDING HEIGHTS AND AREAS

BASE ALLOWABLE PER V-B CONSTRUCTION

B OCCUPANCY - 5 FLOORS / 9,000 MAX PER FLOOR

ACTUAL FLOORS / AREA:

5 FLOORS + 4 MEZZANINE BASEMENT / ??? SF PER FLOOR
THIS IS WITHIN ALLOWABLE WITHOUT TAKING INTO ACCOUNT
FRONTAGE INCREASES. PROJECT INCLUDES NO
BUILDING SQUARE FOOTAGE INCREASE.

CHAPTER 6 - TYPES OF CONSTRUCTION

TYPE ?? CONSTRUCTION PER TABLE 601

STRUCTURAL FRAME	0 HR
BEARING WALLS EXT.	0 HR
BEARING WALLS INT.	0 HR
NON BEARING EXTERIOR WALLS	0 HR
NON BEARING INTERIOR WALLS	0 HR
FLOOR ASSEMBLIES	0 HR
ROOF ASSEMBLIES	0 HR

NOTE: ALL PROPOSED NEW CONSTRUCTION IS INTERIOR, NON BEARING
WALLS. PENETRATIONS AT FLOORS AND ROOF TO BE FIRE STOPPED
PER REQUIRED RATING OF ASSEMBLY

CHAPTER 7 - FIRE RESISTANCE-RATED CONSTRUCTION

708 FIRE PENETRATIONS

EXISTING 1 HOUR RATED CORRIDOR WALLS (FIRE PARTITIONS).
TO BE REPLACED WITH NEW 1 HOUR RATED CONSTRUCTION
WHERE REMOVED.

713 FIRE RESISTANT JOINT SYSTEMS

JOINTS IN OR BETWEEN FIRE RESISTANT RATED WALLS, FLOOR OR
FLOOR / CEILING ASSEMBLIES AND ROOFS SHALL BE PROTECTED BY AN
APPROVED FIRE RESISTANT JOINT SYSTEM WITH A RATING OF NOT LESS
THAN THAT OF THE ASSEMBLY IN WHICH IT IS INSTALLED

717 CONCEALED SPACES

717.2.2 FIRESTOPPING REQUIRED IN SPACES OF STUD WALLS AND
FURRED WALLS AT CEILING AND FLOOR LEVELS AND
HORIZONTALLY AT INTERVALS NOT EXCEEDING 10 FEET.

717.3.3 DRAFTSTOPPING IN FLR/CLG ASSEMBLIES IS NOT REQUIRED IF
SPRINKLERED TO NFPA 13

(CONTINUATION)

CHAPTER 8 - INTERIOR FINISHES

IN ACCORDANCE WITH OCCUPANCY AND CONSTRUCTION TYPE

CHAPTER 9 - FIRE PROTECTION SYSTEMS

NONE

CHAPTER 10 - MEANS OF EGRESS

OCCUPANT LOAD TABLE 1004.1.1

B OCCUPANT LOAD - OFFICE AND SUPPORT SPACES:

???? SF/100 SF OCCUPANT LOAD FACTOR = ?? OCCUPANTS

M1014.3 COMMON PATH OF EGRESS TRAVEL

SHALL NOT EXCEED 75'; SEE DIAGRAMS FOR ILLUSTRATIONS OF LONGEST
COMMON PATH IN PROJECT AREA.

1015.1 EXIT AND EXIT ACCESS DOORWAYS

NEW PROJECT AREA PROVIDED WITH THREE EXITS. TABLE 1015.1

ALLOWS 1 MEANS OF EGRESS FOR OCCUPANT LOAD OF 49 OR FEWER.

1016.1 EXIT ACCESS TRAVEL DISTANCE

TABLE 1016.1 ALLOWS 200' TRAVEL DISTANCE WITHOUT SPRINKLER.

ACTUAL DISTANCES ARE UNDER 200'

1017.1 CORRIDORS

CORRIDORS ARE 1 HOUR RATED CONSTRUCTION

CHAPTER 11 - ACCESSIBILITY

1106 BUILDING ACCESSIBILITY, NEW CONSTRUCTION

NEW CONSTRUCTION TO BE IN ACCORDANCE WITH ACCESSIBILITY
REQUIREMENTS.

1108 FACILITY ACCESSIBILITY

BUILDING HAS EXISTING ACCESSIBLE ENTRY, ELEVATORS AND BATHROOMS

CHAPTER 24 - GLAZING

SECTION 2406 NOTES SAFETY GLAZING REQUIREMENTS

UFC CHAPTER 9, 906 FIRE EXTINGUISHERS

EXTINGUISHER TO BE PROVIDED PROXIMATE TO EACH EXIT FROM PROJECT
AREA

General Notes		
	XXX	xx/xx/13
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DRAWING TITLE: CODE ANALYSIS

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DESIGN SERVICES GROUP
1295 FRANKLIN BOULEVARD
EUGENE, OREGON 97403-1216
(541) 346-2270

FACILITIES SERVICES
1276 UNIVERSITY OF OREGON
EUGENE, OREGON 97403-1216

PROJECT NAME:
KNIGHT LIBRARY
1ST FLOOR
THE DIGITAL
SCHOLARSHIP CTR


PROJECT NO:
WK224612

DATE:
06/12/2013

DESIGN/DRAWN BY:
KS/MNL

SCALE:
AS NOTED

DRAWING NO:
G003

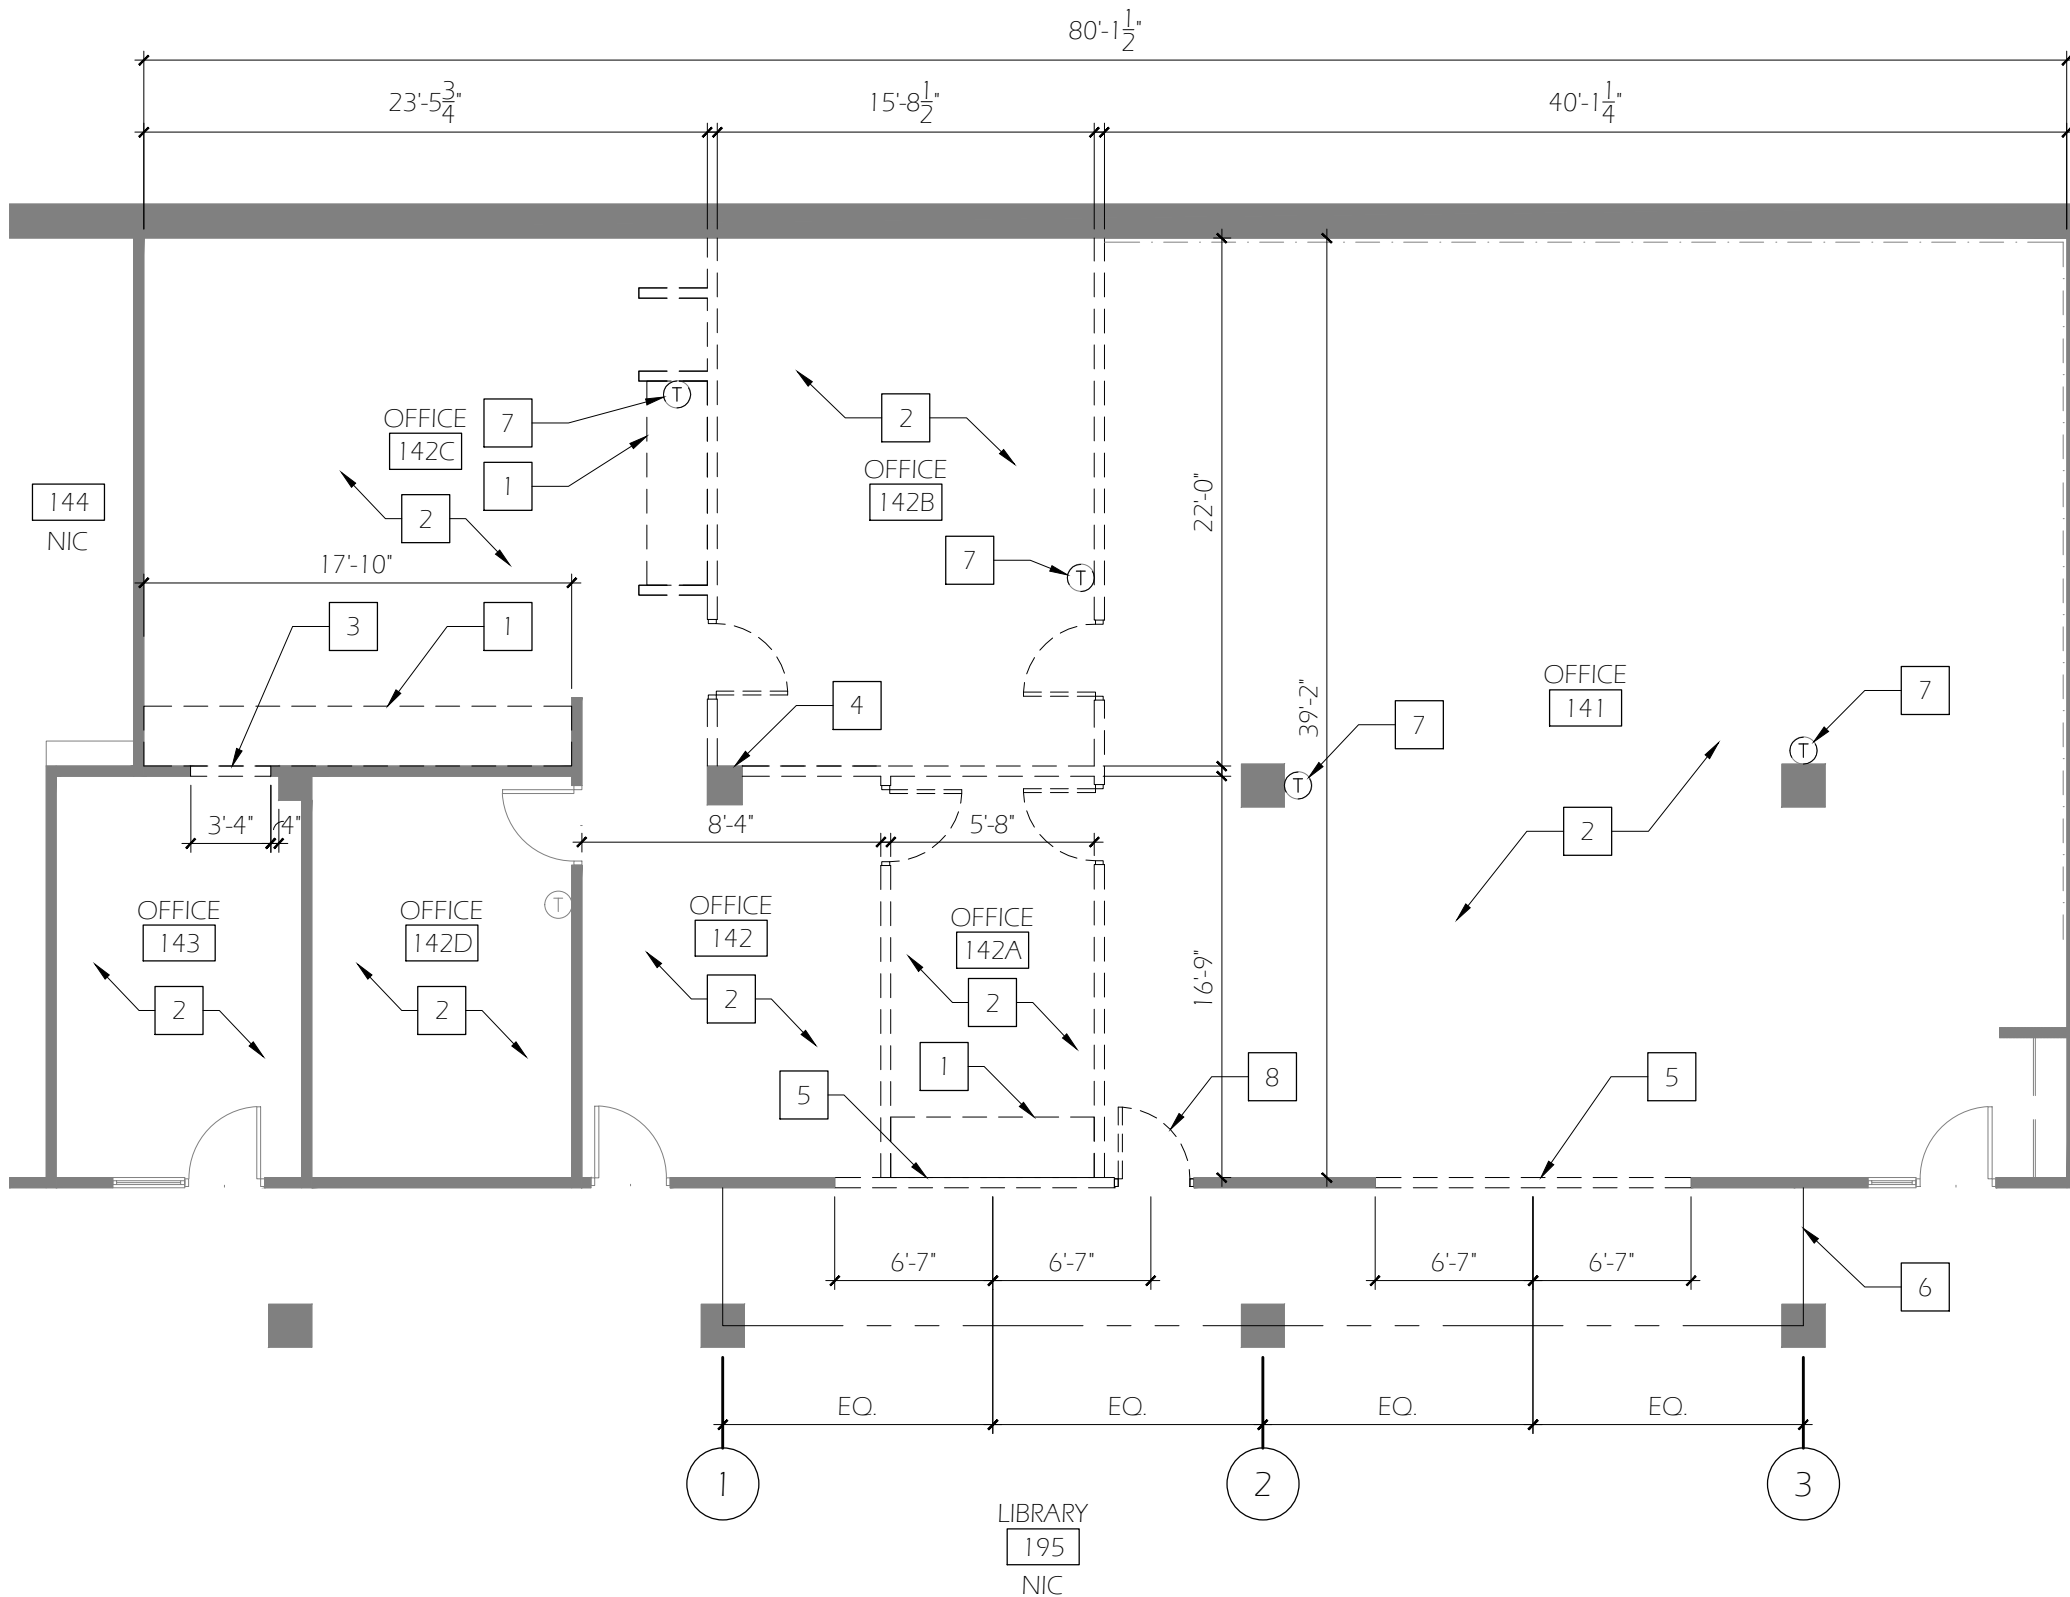

1 DEMOLITION FLOOR PLAN
 A001 Scale: 1/8" = 1'-0"



GENERAL NOTES

1. PROTECT & PRESERVE ADJACENT (E) FINISHES TO REMAIN FROM DAMAGE CAUSED BY DEMOLITION & CONSTRUCTION. CONTRACTOR TO REPAIR INCIDENTAL DAMAGE AT OWN EXPENSE.
2. (E) EQUIPMENT, FURNITURE TO BE REMOVED & SALVAGED WHEN POSSIBLE
3. DEMO CARPET & WALL BASE AS NOTED, TAKING CARE TO MINIMIZED DISTURBANCE OF RESILIENT TILE SUBSTRATE. ANY NECESSARY OR DESIRED ABATEMENT TO BE COORDINATED BY OWNER
4. ASBESTOS SURVEY AND ABATEMENT BY OWNER PRIOR TO CONSTRUCTION

DEMO PLAN KEYED NOTES

- 1 DEMO EXISTING CASEWORK/SHELVES
- 2 DEMO CARPET
- 3 SELECTIVE DEMOLITION OF EXISTING WALL STUDS FOR INSTALLATION OF NEW DOOR AND FRAME
- 4 FIELD VERIFY EXISTING CONDITIONS AT COLUMN. PREP AS REQUIRED TO FURR OUT COLUMN TO ACHIEVE UNIFORM CONTINUOUS FINISH
- 5 SELECTIVE DEMOLITION OF WALL FOR INSTALLATION OF TRANSOM GLAZING. REFER TO NEW WORK TO COORDINATE DIMENSIONS AND LOCATIONS
- 6 INSTALL TEMPORARY DUST PARTITION TO PROTECT ADJACENT AREA IN USE DURING RENOVATION
- 7 EXISTING THERMOSTAT TO BE REMOVED
- 8 SALVAGE DOOR FOR REINSTALLATION

LEGEND

- ==== DEMO WALL UP TO 2" BELOW ACOUSTIC CEILING TILE AT 9'-0" A.F.F. UNLESS NOTED OTHERWISE. SEE DETAIL 1/A401
- - - - REMOVE & SALVAGE DOOR & FRAME
- _____ TEMPORARY DUST PARTITION UP TO ACOUSTIC CEILING TILE FOR INSTALLATION OF TRANSOM GLAZING

General Notes		
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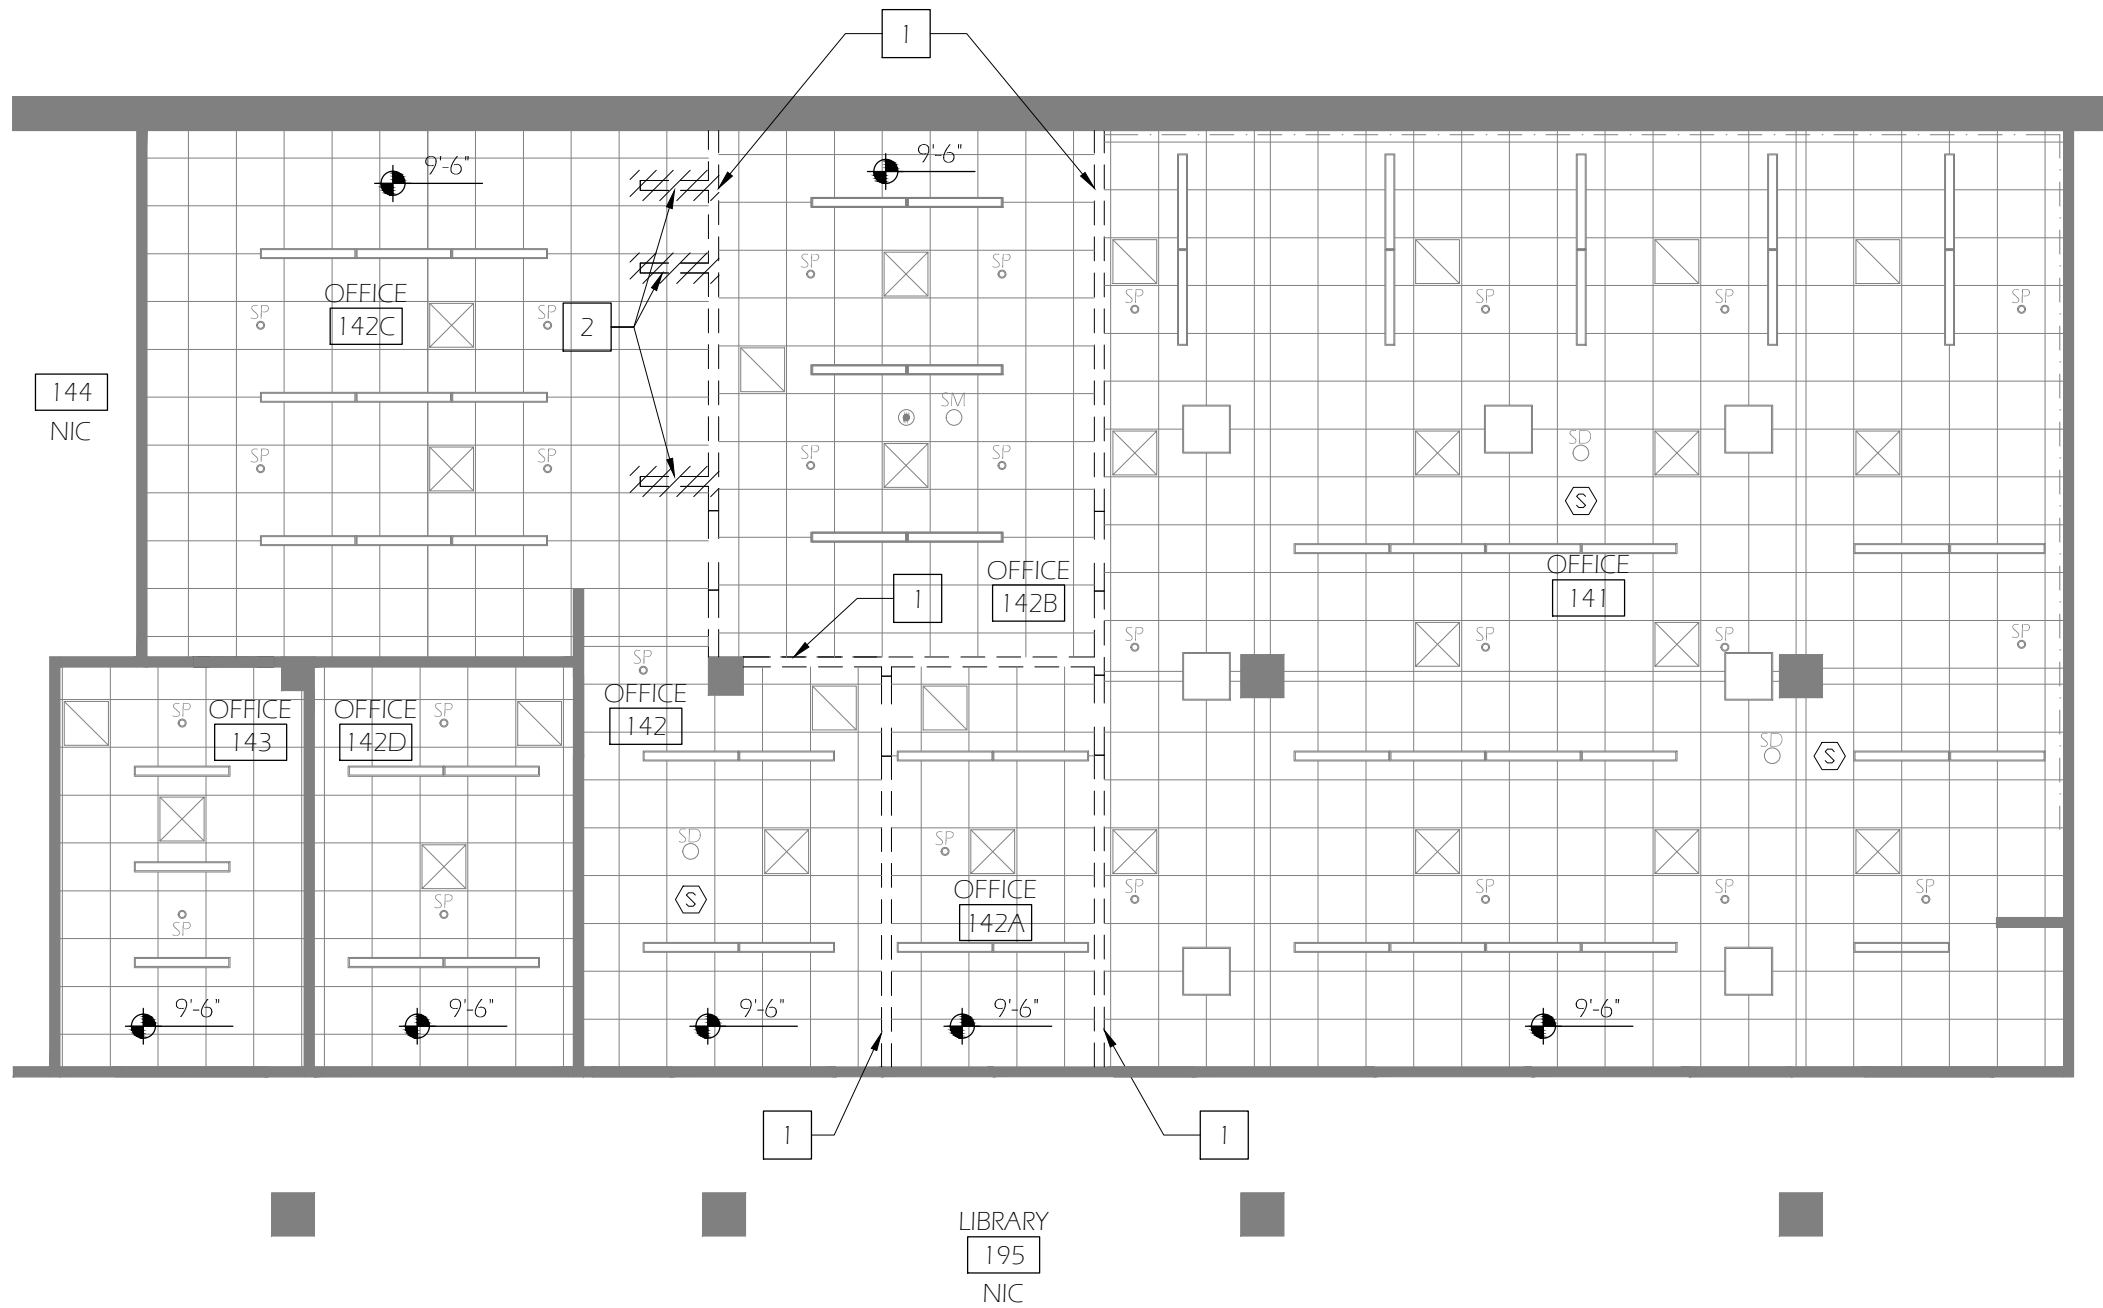


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 06/12/2013
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A001



GENERAL NOTES

1. PROTECT AND PRESERVE ADJACENT FINISHES TO REMAIN FROM DAMAGE CAUSED BY DEMOLITION AND CONSTRUCTION. CONTRACTOR TO REPAIR INCIDENTAL DAMAGE AT OWN EXPENSE.
2. NO NEW SPRINKLER WORK REQUIRED UNDER BASE BID
3. UNLESS NOTED BY KEYED NOTE 3. ALL CEILING GRID AND TILE TO REMAIN

DEMO PLAN KEYED NOTES

1. EXISTING WALL TO BE REMOVED UP TO 2" BELOW EXISTING GRID, SEE A001 FOR DIMENSIONS
2. REMOVE WALL UP TO STRUCTURE ABOVE. REMOVE IMPACTED ACOUSTIC CEILING TILE AND GRID AS REQUIRED FOR REINSTALLATION TO MATCH ADJACENT

LEGEND

- ⊗ EXISTING FIRE ALARM
- ⌘ SWITCH, SINGLE POLE
- Ⓡ EXISTING THERMOSTAT
- ⊗ EXISTING SUPPLY GRILLE
- ⊗ EXISTING RETURN GRILLE
- LIGHT
- LIGHT
- Ⓢ SPEAKER
- Ⓢ SMOKE DETECTOR

General Notes		
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DEMOLITION RCP

PROJECT NAME:
KNIGHT LIBRARY
1ST FLOOR
THE DIGITAL
SCHOLARSHIP CTR

PROJECT NO.:
WK224612


DATE:
06/12/2013

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SCALE:
AS NOTED

DRAWING NO.:
A002

1 A002 DEMOLITION REFLECTED CEILING PLAN - BASE BID WORK Scale: 1/8" = 1'-0"

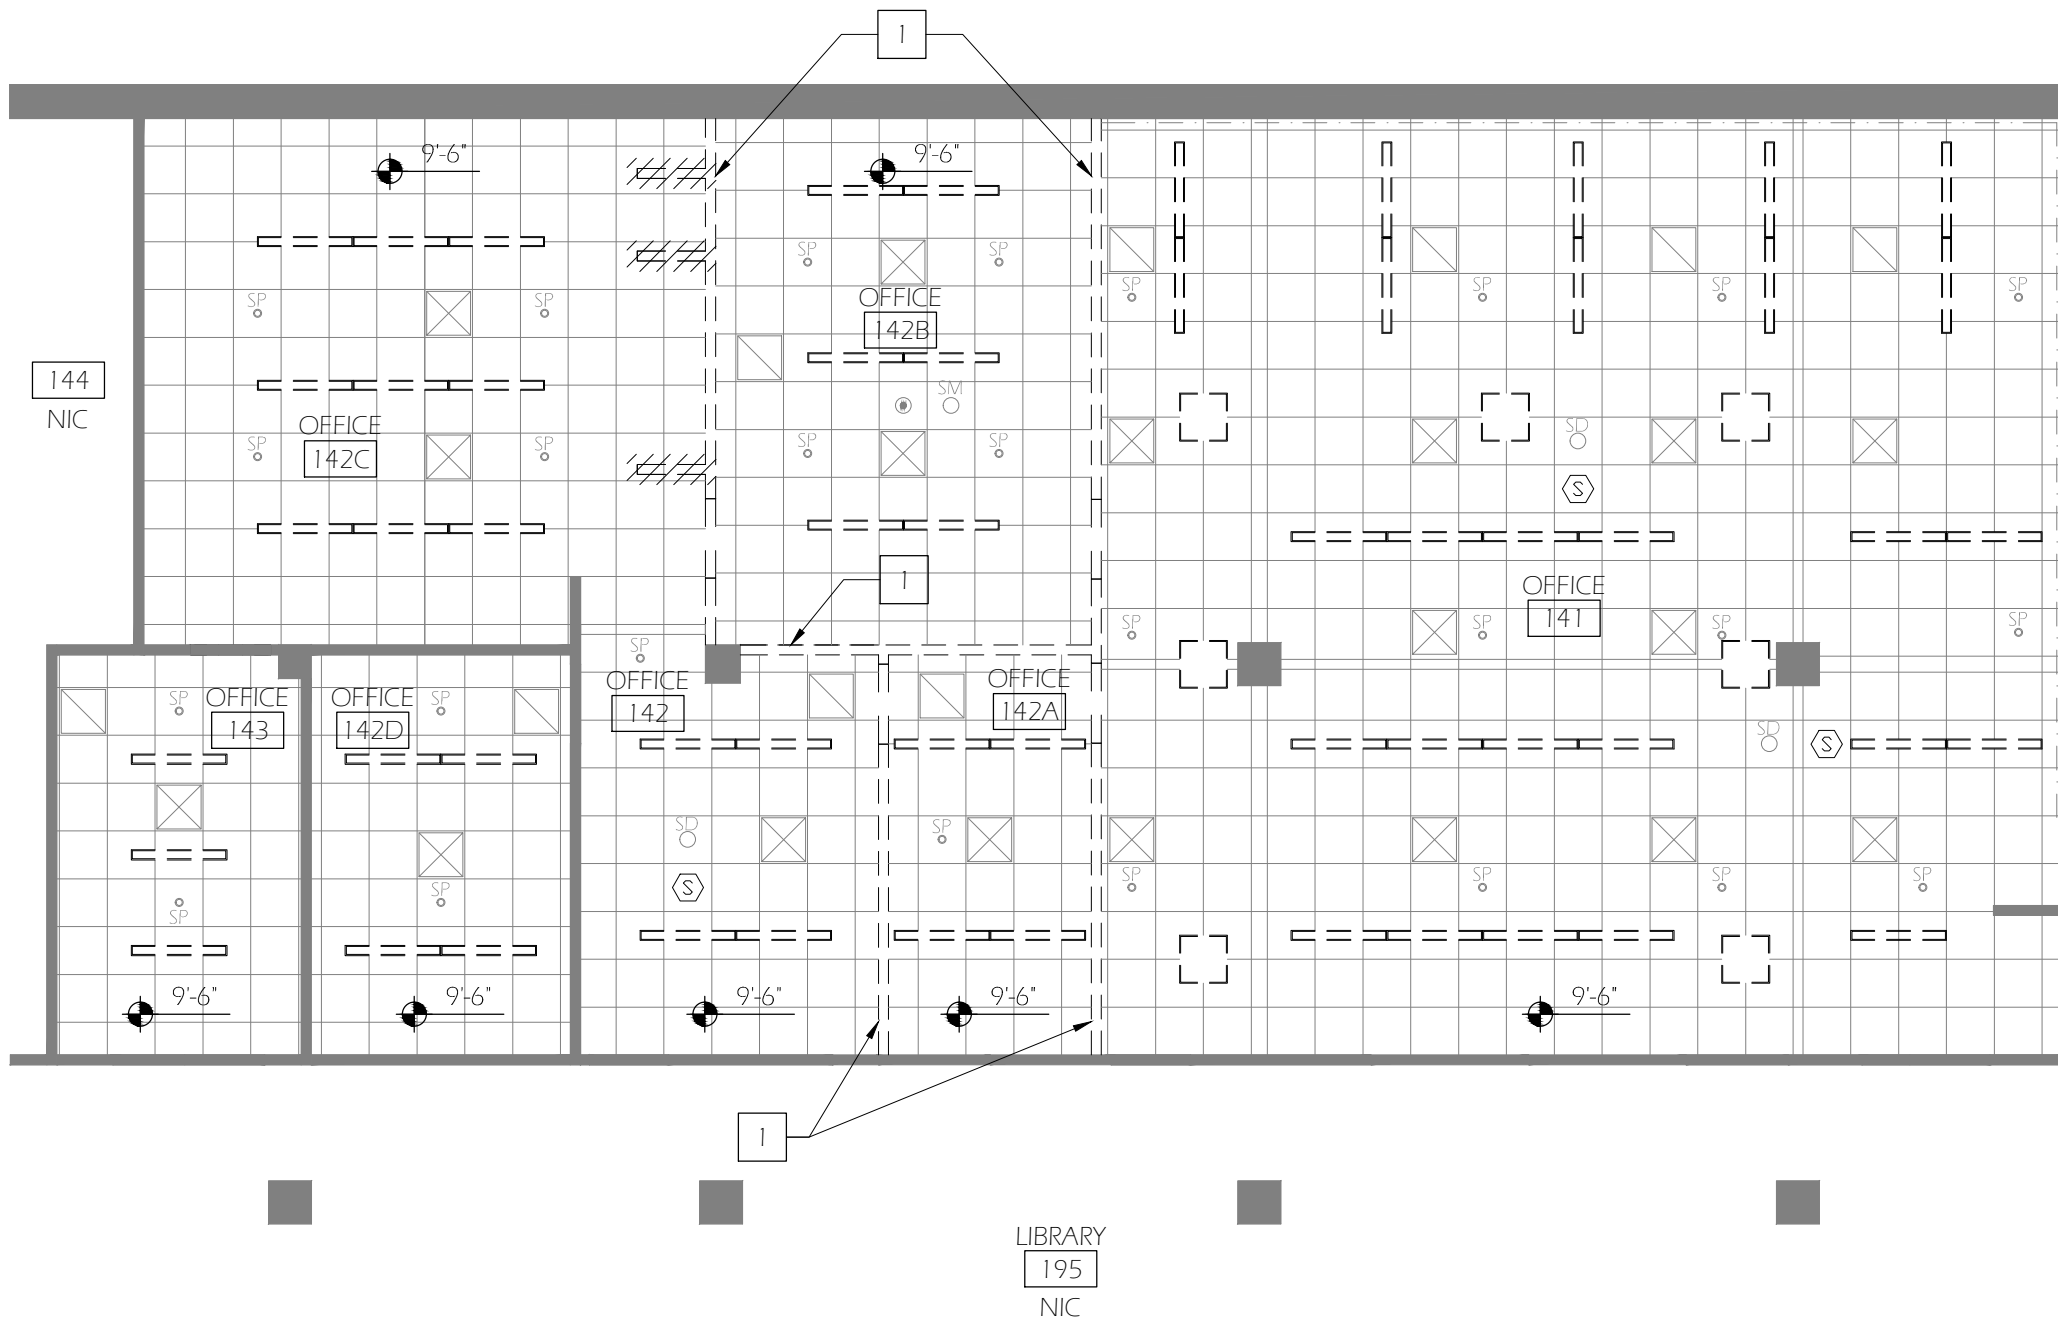

GENERAL NOTES

1. PROTECT AND PRESERVE ADJACENT FINISHES TO REMAIN FROM DAMAGE CAUSED BY DEMOLITION AND CONSTRUCTION. CONTRACTOR TO REPAIR INCIDENTAL DAMAGE AT OWN EXPENSE.
2. NO NEW SPRINKLER WORK REQUIRED UNDER BASE BID

DEMO PLAN KEYED NOTES

- 1 EXISTING WALL TO BE REMOVED UP TO 2" BELOW EXISTING GRID, SEE A001

LEGEND

- ⊗ EXISTING FIRE ALARM
- ⊠ EXISTING SUPPLY GRILLE
- ⊡ EXISTING RETURN GRILLE
- — — LIGHT FIXTURE TO BE REMOVED
- SP SPRINKLER HEAD
- SM SMOKE DETECTOR
- Ⓢ SPEAKER

General Notes		
No.	Revisory/Issue	Date



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 1295 FRANKLIN BOULEVARD
 EUGENE, OREGON 97403-12176
 (541) 346-2270

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 FACILITIES SERVICES
 1276 UNIVERSITY OF OREGON
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DEMOLITION RCP

PROJECT NAME:
 KNIGHT LIBRARY
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PROJECT NO.:
 WK224612

DATE:
 06/12/2013


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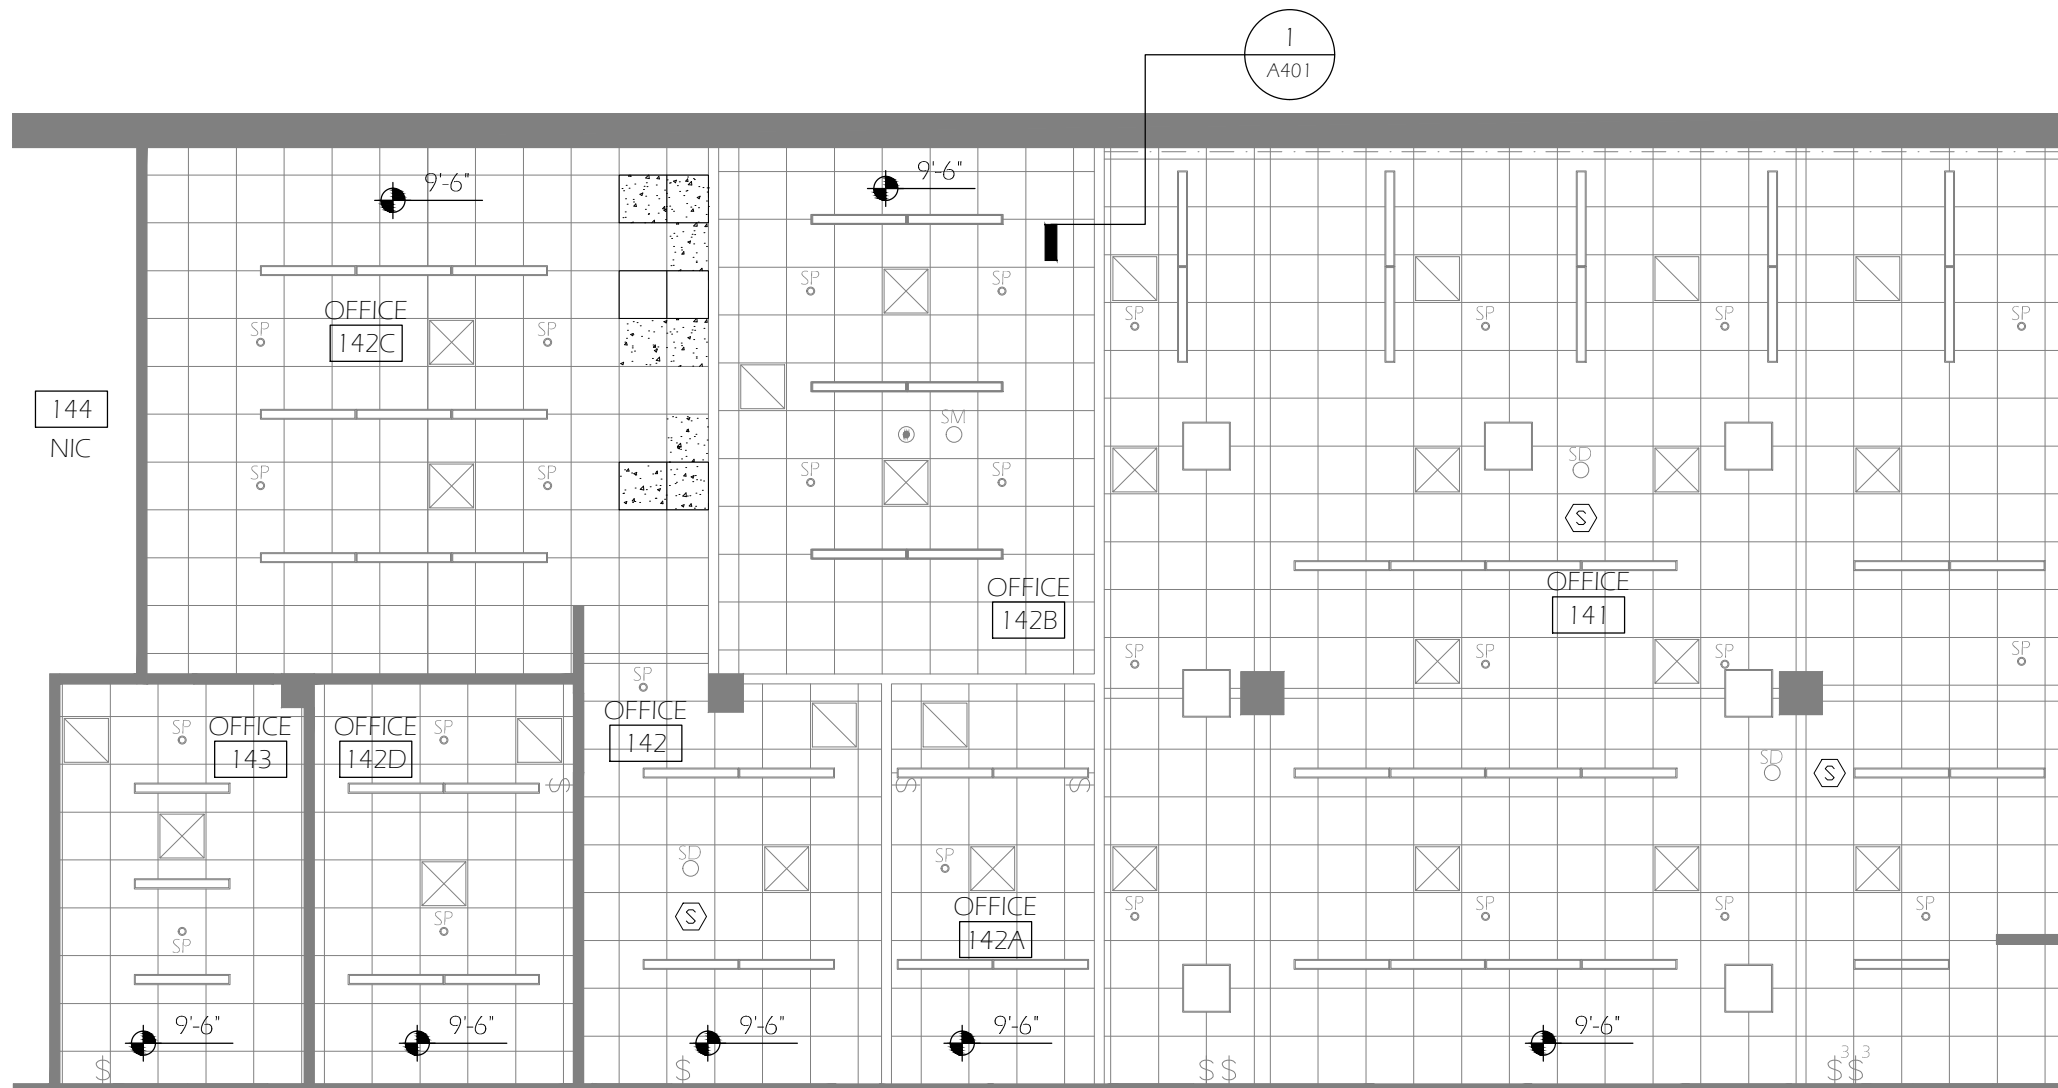
SCALE:
 AS NOTED

DRAWING NO.:

A003

1
 A003
DEMOLITION REFLECTED CEILING PLAN - ALTERNATE 1
 Scale: 1/8" = 1'-0"



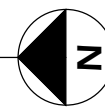

GENERAL NOTES

1. PROTECT AND PRESERVE ADJACENT FINISHES TO REMAIN FROM DAMAGE CAUSED BY DEMOLITION AND CONSTRUCTION. CONTRACTOR TO REPAIR INCIDENTAL DAMAGE AT OWN EXPENSE.
2. NO NEW SPRINKLER WORK REQUIRED UNDER BASE BID
3. UNLESS NOTED BY KEYED NOTE 3. ALL CEILING GRID AND TILE TO REMAIN

PLAN KEYED NOTES

- 1 NOT USED
- 2 EXISTING WALL TO BE REMOVED UP TO 2" BELOW EXISTING GRID, SEE A001 FOR DIMENSIONS
- 3 REMOVE WALL UP TO STRUCTURE ABOVE. REMOVE IMPACTED ACOUSTIC CEILING TILE AND GRID AS REQUIRED FOR REINSTALLATION TO MATCH ADJACENT

LEGEND

- ⊗ EXISTING FIRE ALARM
- \$ EXISTING SWITCH, SINGLE POLE
- Ⓢ EXISTING THERMOSTAT
- ⊗ EXISTING SUPPLY GRILLE
- ⊗ EXISTING RETURN GRILLE
- EXISTING LIGHT
- EXISTING LIGHT
- Ⓢ EXISTING SPEAKER
- Ⓢ EXISTING SMOKE DETECTOR
- ▨ INDICATES NEW CEILING TILE IN EXISTING GRID, TO BE ARMSTRONG CORTEGA 770 24x24x5/8"

General Notes		
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 (541) 346-2270

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NEW WORK RCP

DRAWING TITLE

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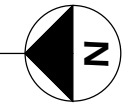
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SCALE:
 AS NOTED

DRAWING NO.:
A102

1 NEW WORK REFLECTED CEILING PLAN - BASE BID WORK
 Scale: 1/8" = 1'-0"



ROOM FINISH SCHEDULE

RM. NO.	ROOM NAME	FLOOR		BASE MAT.	NORTH			EAST			SOUTH			WEST			CEILING		REMARKS
		MAT.			WALL ELEV.	PAINT	NOTE	WALL ELEV.	PAINT	NOTE	WALL ELEV.	PAINT	NOTE	WALL ELEV.	PAINT	NOTE	FINISH	HEIGHT	
141	OPEN OFFICE	CN	-	R	-	P-1		-	P-2		1/A401	P-1		-	P-1		-	-	
142	OFFICE	CN	-	R	-	P-2		-	P-1		-	P-1		-	P-1		-	-	
143	OFFICE	CN	-	R	-	P-2		-	P-1		-	P-1		-	P-1		-	-	

LEGEND

P1 GENERAL BASE COLOR
P2 OFFICE ACCENT

E EXISTING
CE CARPET, EXISTING
CN CARPET, NEW
R RUBBER BASE, NEW

P - PAINT
S - STAIN

GENERAL NOTES


- DOOR HARDWARE SUPPLIED BY UO LOCKSHOP, INSTALLED BY G.C.
- HARDWARE TYPES
GROUP 1 - PANIC/EXIT HARDWARE
GROUP 2 - OFFICE FUNCTION
GROUP 3 - CLOSET FUNCTION
- FIELD VERIFY BLIND DIMENSIONS

DOOR SCHEDULE

DOOR		FRAME			DOOR			HARDWARE	NOTES
NO.	NAME	TYPE	FINISH	MATERIAL	TYPE	FINISH	MATERIAL		
141A	OPEN OFFICE	E	P	M	E	E	-		
143B	OFFICE	F-1	P	M	D-1	S	-	GROUP 2	

KEYED NOTES

- 1 REPLACE GLASS

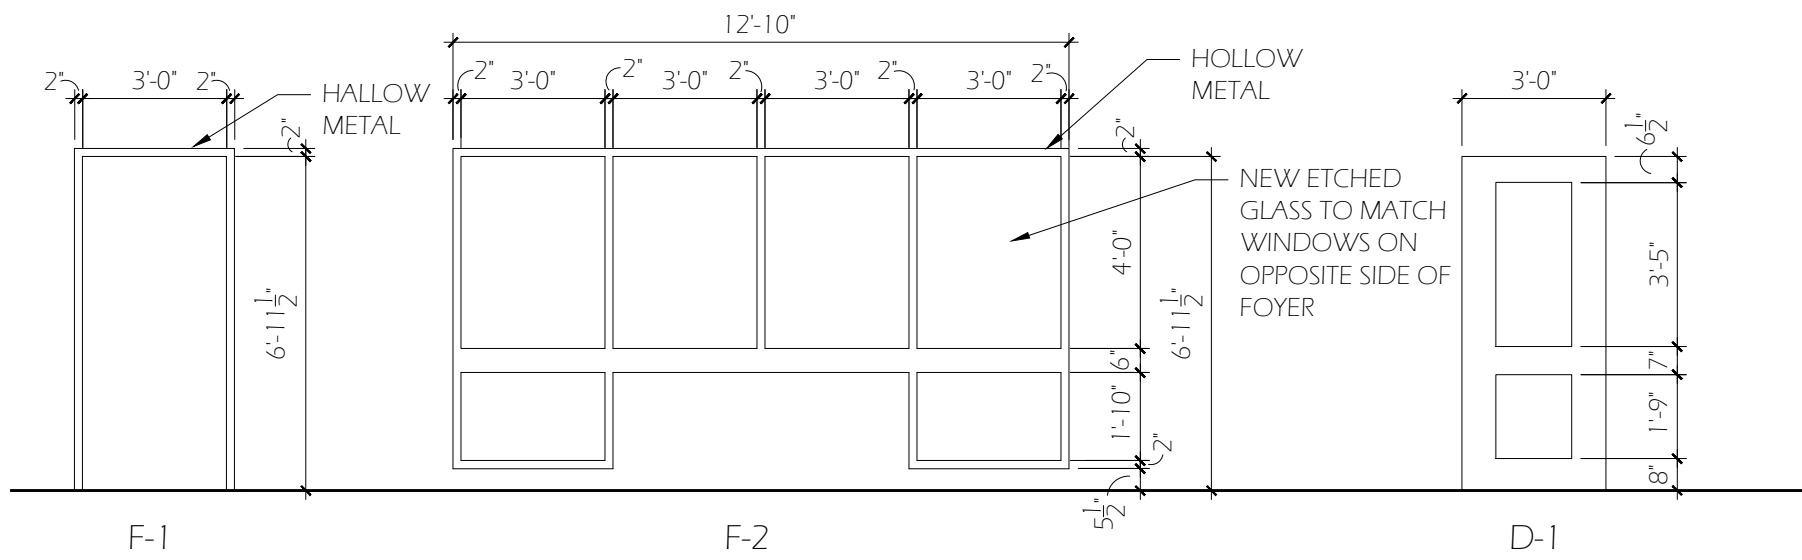

General Notes

No. Revison/Issue Date



ROOM/DOOR SCHEDULE

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PROJECT NAME:
KNIGHT LIBRARY
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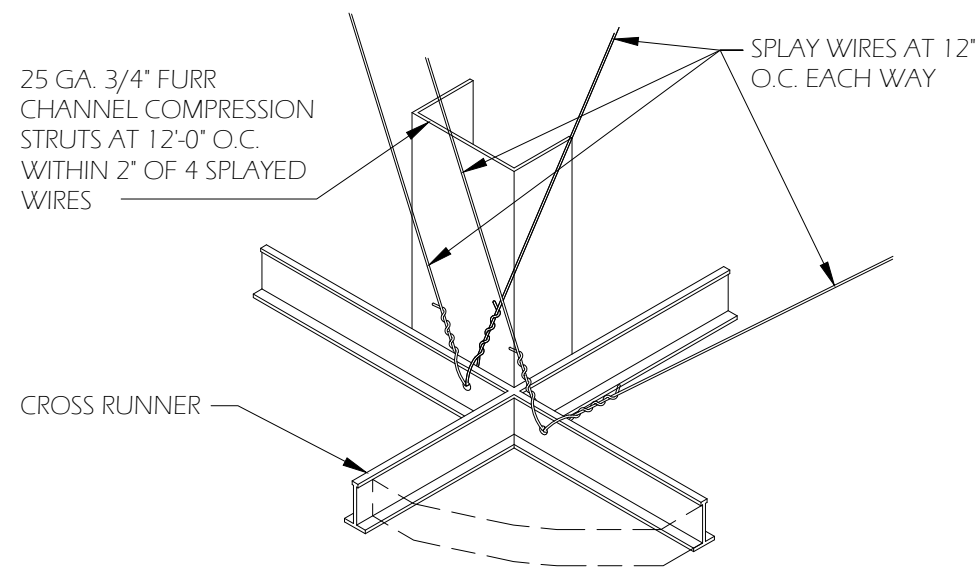
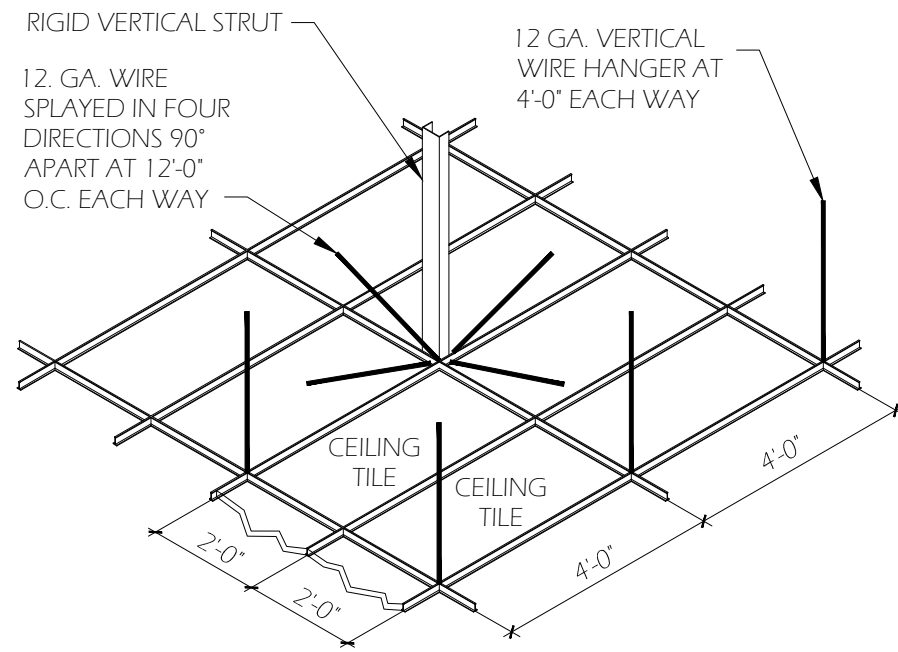
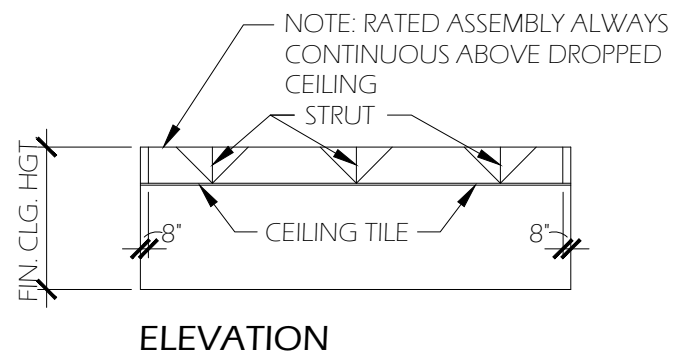
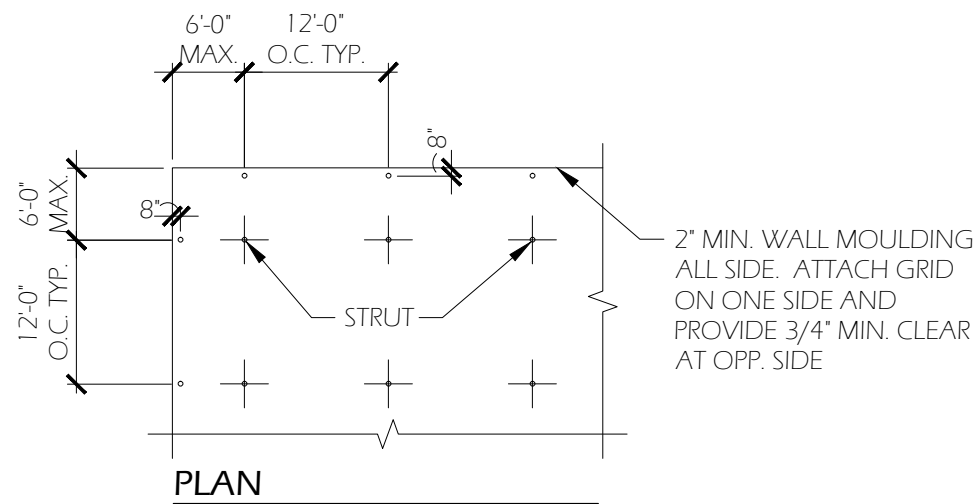
PROJECT NO.:
WK224612

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06/12/2013

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SCALE:
AS NOTED

DRAWING NO.:
A501



1. SUSPENDED CEILING S TO COMPLY WITH OSSC REQUIREMENTS AND OREGON BULLETIN 401.
2. BULLETIN 401 IS AVAILABLE FROM NORTHWEST WALL AND CEILING BUREAU.
3. PROVIDE SPREADER BARS AT PERIMETER WALLS PER BULLETIN 401
4. PROVIDE SEISMIC SEPARATION JOINT FOR CEILING AREAS OVER 2500 SF.
5. SPRINKLER HEAD PENETRATIONS SHALL ALLOW 1" OF FREE MOVEMENT FOR THE SPRINKLER HEAD. THIS MAY BE PROVIDED BY FLEXIBLE HEAD DESIGN OR OVERSIZE RING OR SLEEVE.
6. VERTICAL STRUTS FASTENED TO THE MAIN RUNNER SHALL BE EXTENDED TO AND FASTENED TO THE STRUCTURE MEMBER SUPPORTING THE ROOF/CEILING ABOVE. THE STRUT SHALL BE ADEQUATE TO RESIST THE VERTICAL COMPONENT INDUCED BY BRACING WIRES.
7. THESE HORIZONTAL RESTRAINTS SHALL BE PLACED 12'-0" IN BOTH DIRECTIONS WITH THE FIRST POINT WITHIN 6'-0" FROM WALL.
8. RIGID VERTICAL STRUTS MAY BE STEEL, BLACK IRON, EMT OR OTHER APPROVED CONSTRUCTION.
9. PROVIDE 12 GA. WIRE HANGERS AT ALL FOUR (4) CORNERS OF EACH LIGHT FRAME.

TYPICAL SUSPENDED CEILING DETAIL

General Notes		
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DRAWING TITLE: **SUSPENDED CEILING DETAILS**

UNIVERSITY OF OREGON

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1295 FRANKLIN BOULEVARD
(541) 346-2270

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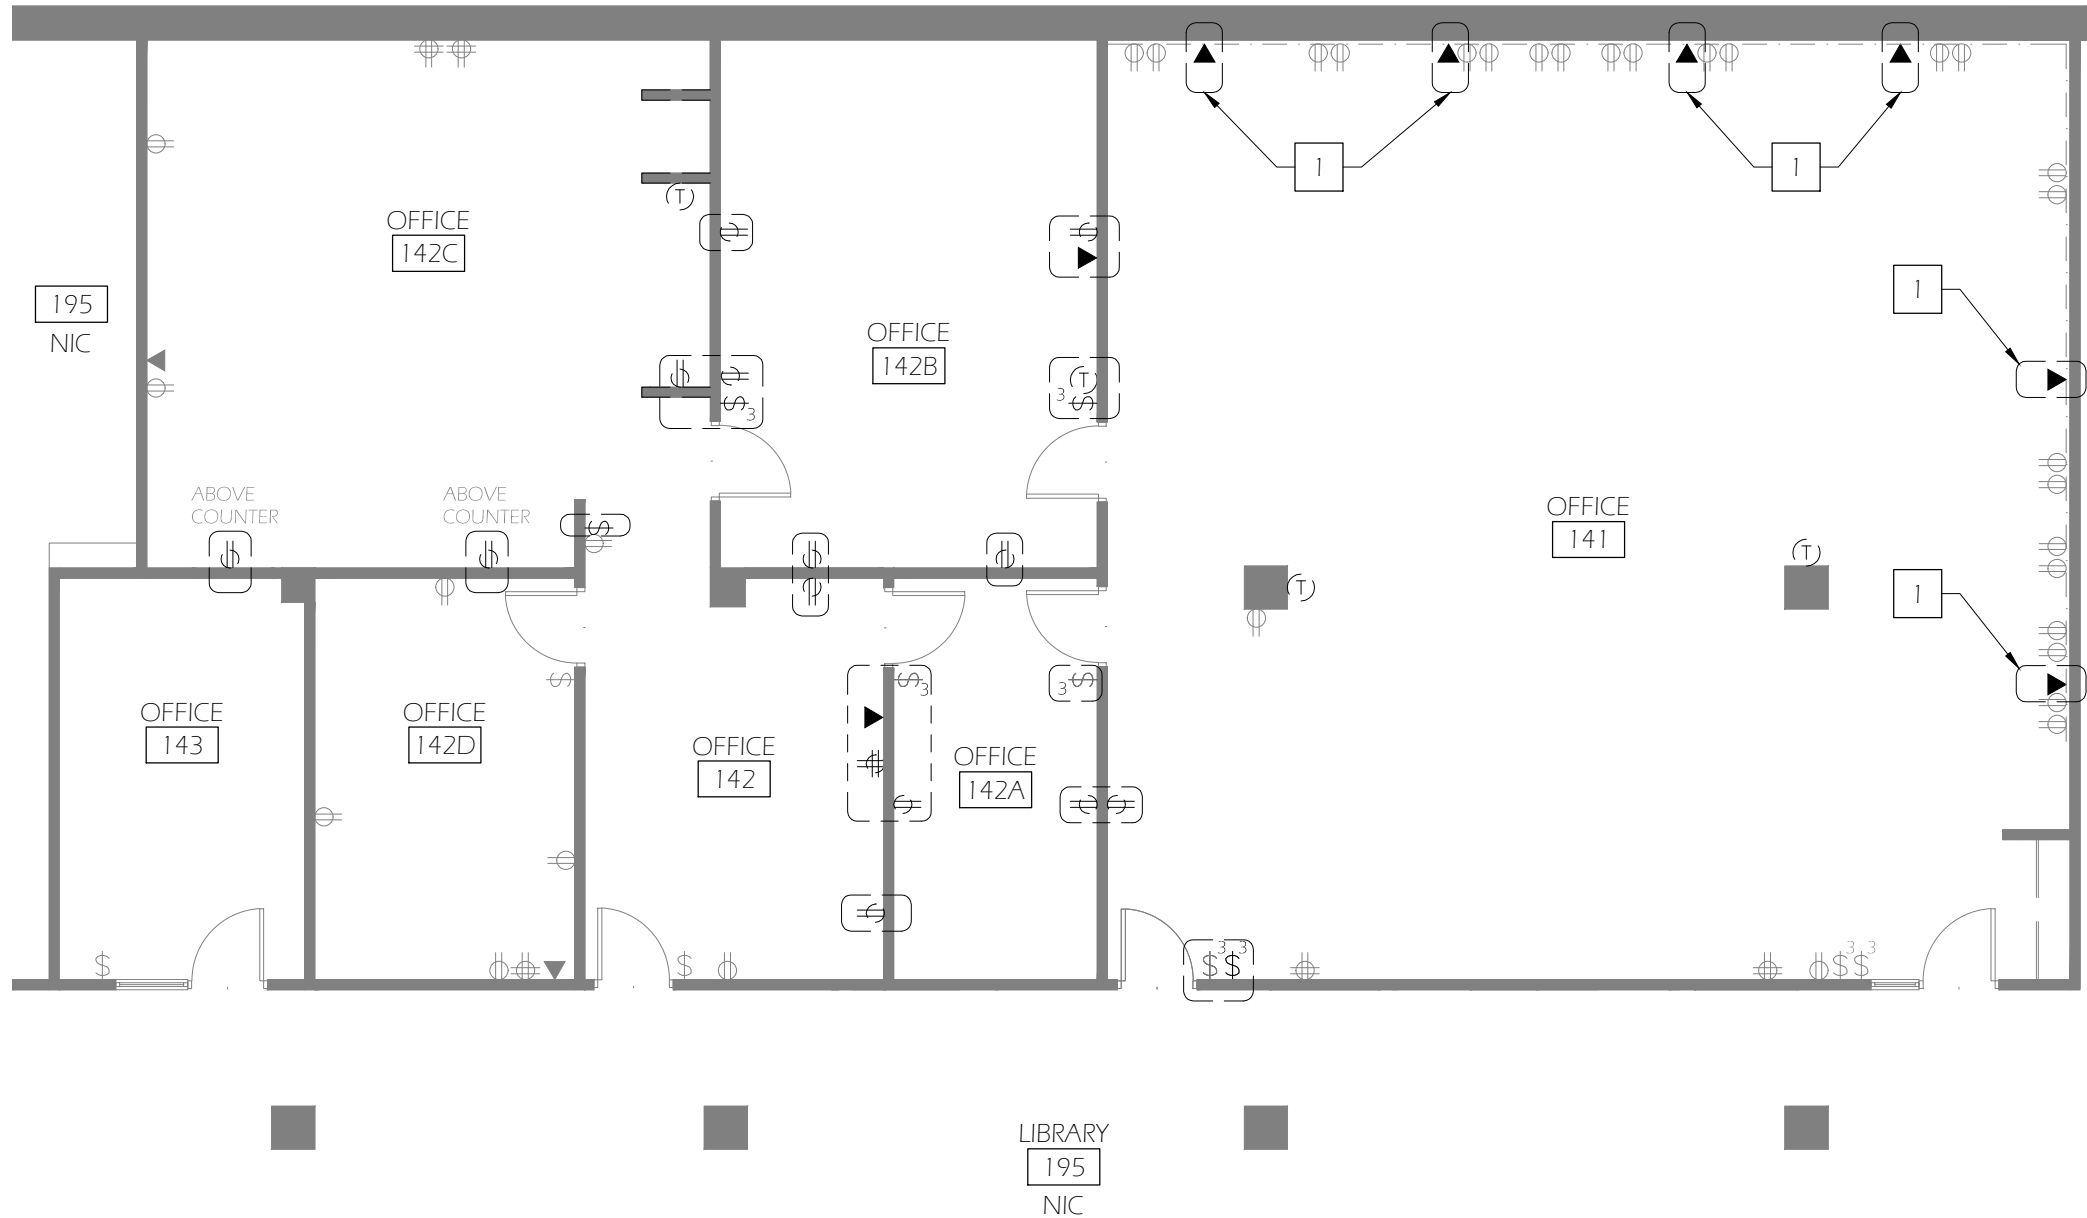
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06/12/2013

DESIGN/DRAWN BY:
KS/MNL

SCALE:
AS NOTED

DRAWING NO:
A502



GENERAL NOTES

1. PROTECT & PRESERVE ADJACENT (E) FINISHES TO REMAIN FROM DAMAGE CAUSED BY DEMOLITION & CONSTRUCTION. CONTRACTOR TO REPAIR INCIDENTAL DAMAGE AT OWN EXPENSE

KEYED NOTES

- 1 REMOVE EXISTING DATA FACEPLATE; RACEWAY TO REMAIN

LEGEND

- INDICATES FIXTURE TO BE REMOVED; LIGHT SWITCH, OUTLET, DATA & THERMOSTAT
- EXISTING 4000 SERIES WIREMOLD TO REMAIN

General Notes		
▲	XXX	xx/xx/13
No.	Revision/Issue	Date



UNIVERSITY OF OREGON

DESIGN SERVICES GROUP
1295 FRANKLIN BOULEVARD
EUGENE, OREGON 97403-1276
(541) 346-2270

DESIGN SERVICES
1276 UNIVERSITY OF OREGON
EUGENE, OREGON 97403-1276

DEMO ELECTRICAL PLAN

PROJECT NAME:
KNIGHT LIBRARY
1ST FLOOR
THE DIGITAL
SCHOLARSHIP CTR

PROJECT NO.:
WK224612


DATE:
06/12/2013


DESIGN/DRAWN BY:
KS/MNL

SCALE:
AS NOTED

DRAWING NO.:
E001

1 DEMOLITION ELECTRICAL FLOOR PLAN
E001 Scale: 1/8" = 1'-0"

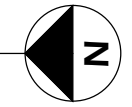

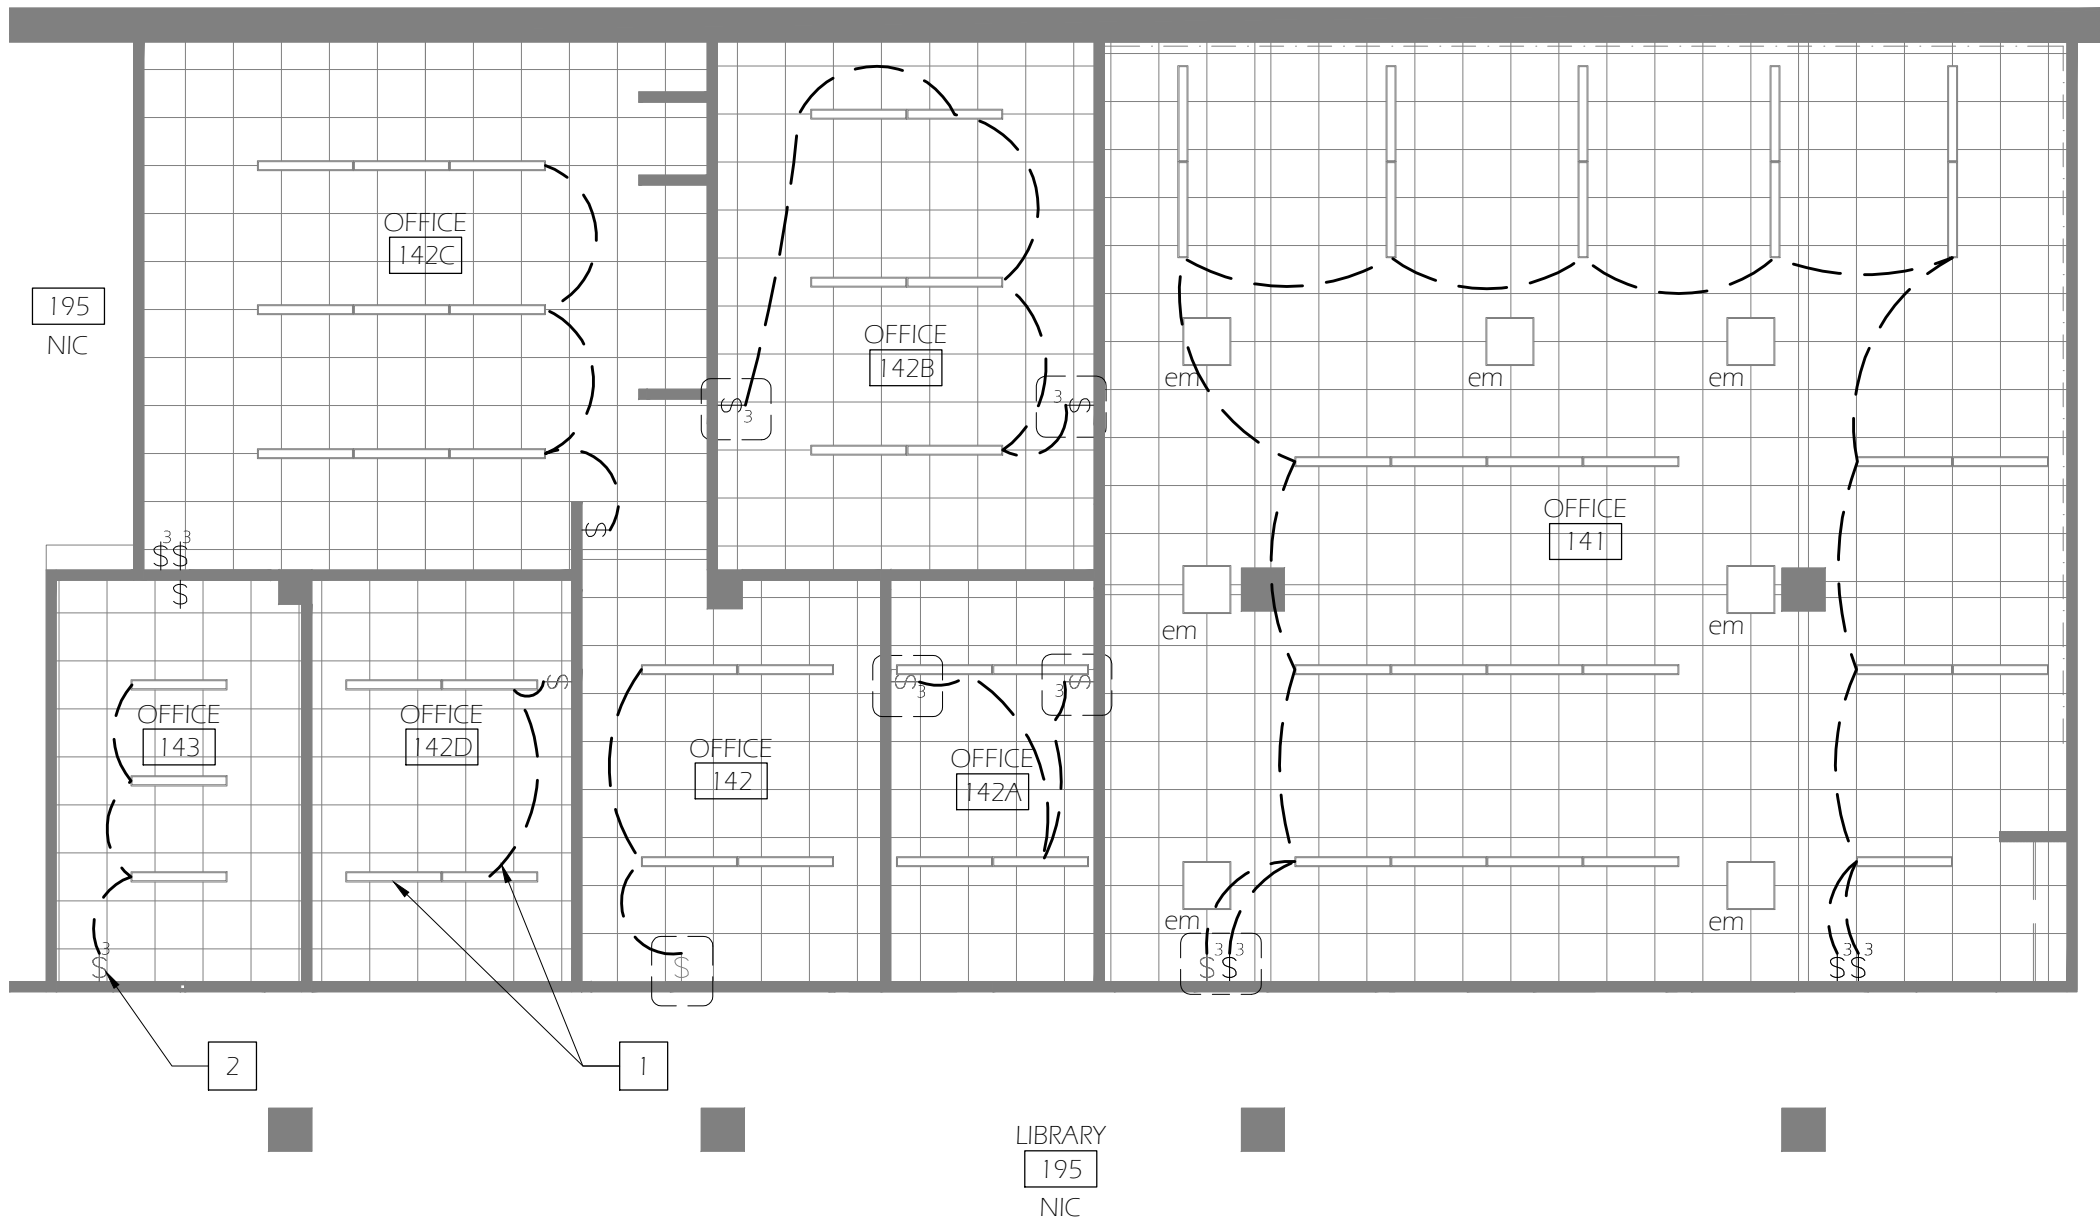

GENERAL NOTES

1. PROTECT & PRESERVE ADJACENT (E) FINISHES TO REMAIN FROM DAMAGE CAUSED BY DEMOLITION & CONSTRUCTION. CONTRACTOR TO REPAIR INCIDENTAL DAMAGE AT OWN EXPENSE

KEYED NOTES

- 1 LIGHTING/SWITCHING IN THIS ROOM TO REMAIN
- 2 REMOVE EXISTING SWITCH, PREP FOR INSTALLATION OF NEW THREE WAY SWITCH

LEGEND

- - - INDICATES WIRING BETWEEN EXISTING SWITCH AND LIGHTING TO BE REMOVED
- [] INDICATES FIXTURE TO BE REMOVE.

General Notes		
▲	XXX	xx/xx/13
No.	Revision/Issue	Date



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DESIGN SERVICES GROUP
1295 FRANKLIN BOULEVARD
EUGENE, OREGON 97403-1216
(541) 346-2270

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1276 UNIVERSITY OF OREGON
EUGENE, OREGON 97403-1216

DRAWING TITLE: **DEMO ELECTRICAL PLAN**

PROJECT NAME:
KNIGHT LIBRARY
1ST FLOOR
THE DIGITAL
SCHOLARSHIP CTR

PROJECT NO.:
WK224612


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06/12/2013


DESIGN/DRAWN BY:
KS/MNL

SCALE:
AS NOTED

DRAWING NO.:
E002

1 DEMOLITION ELECTRICAL REFLECTED CEILING PLAN
E002 Scale: 1/8" = 1'-0"

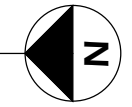

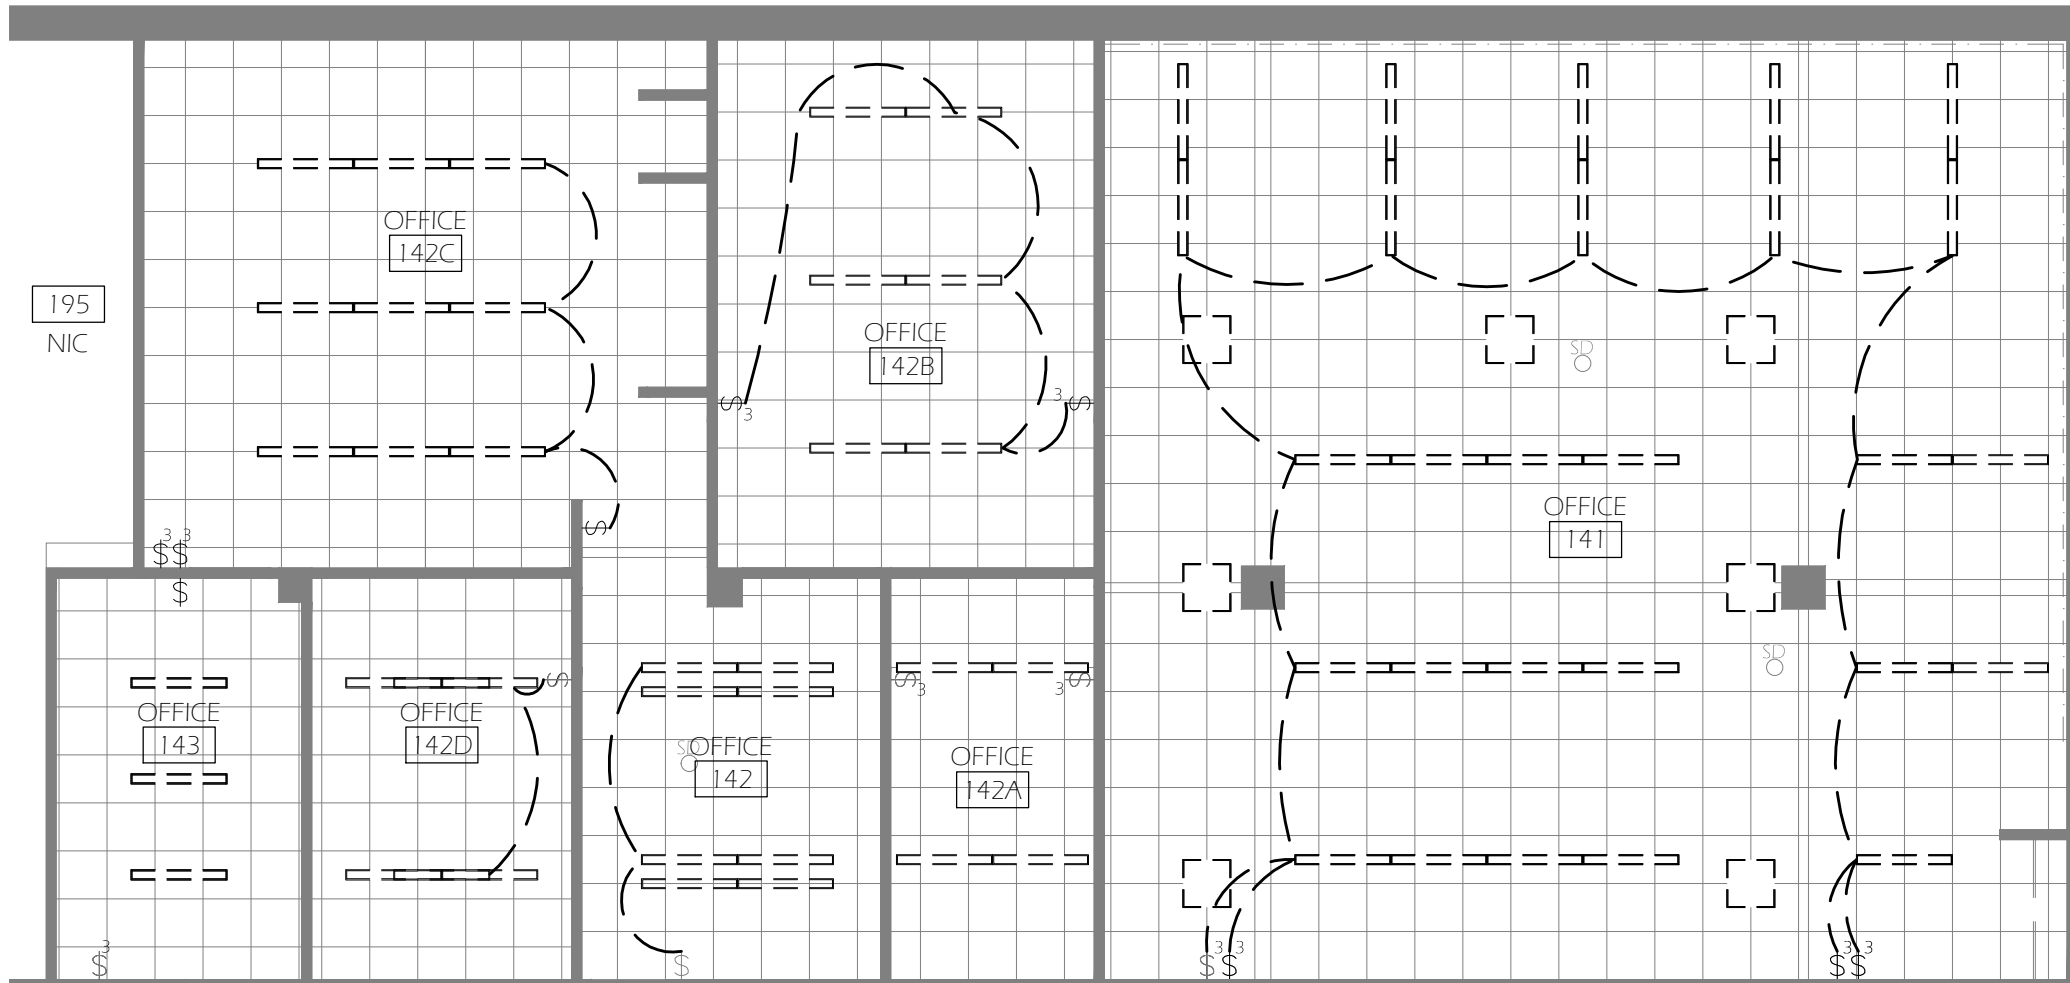

GENERAL NOTES

1. PROTECT & PRESERVE ADJACENT (E) FINISHES TO REMAIN FROM DAMAGE CAUSED BY DEMOLITION & CONSTRUCTION. CONTRACTOR TO REPAIR INCIDENTAL DAMAGE AT OWN EXPENSE

KEYED NOTES

1 XX

LEGEND

--- DEMO LIGHT

- - - INDICATES WIRING BETWEEN EXISTING SWITCH AND LIGHTING TO BE REMOVED

General Notes		
▲	XXX	xx/xx/13
No.	Revision/Issue	Date



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DESIGN SERVICES GROUP
1295 FRANKLIN BOULEVARD
EUGENE, OREGON 97403-1276
(541) 346-2270

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DRAWING TITLE: **DEMO ELECTRICAL PLAN**

PROJECT NAME:
KNIGHT LIBRARY
1ST FLOOR
THE DIGITAL
SCHOLARSHIP CTR

PROJECT NO.:
WK224612


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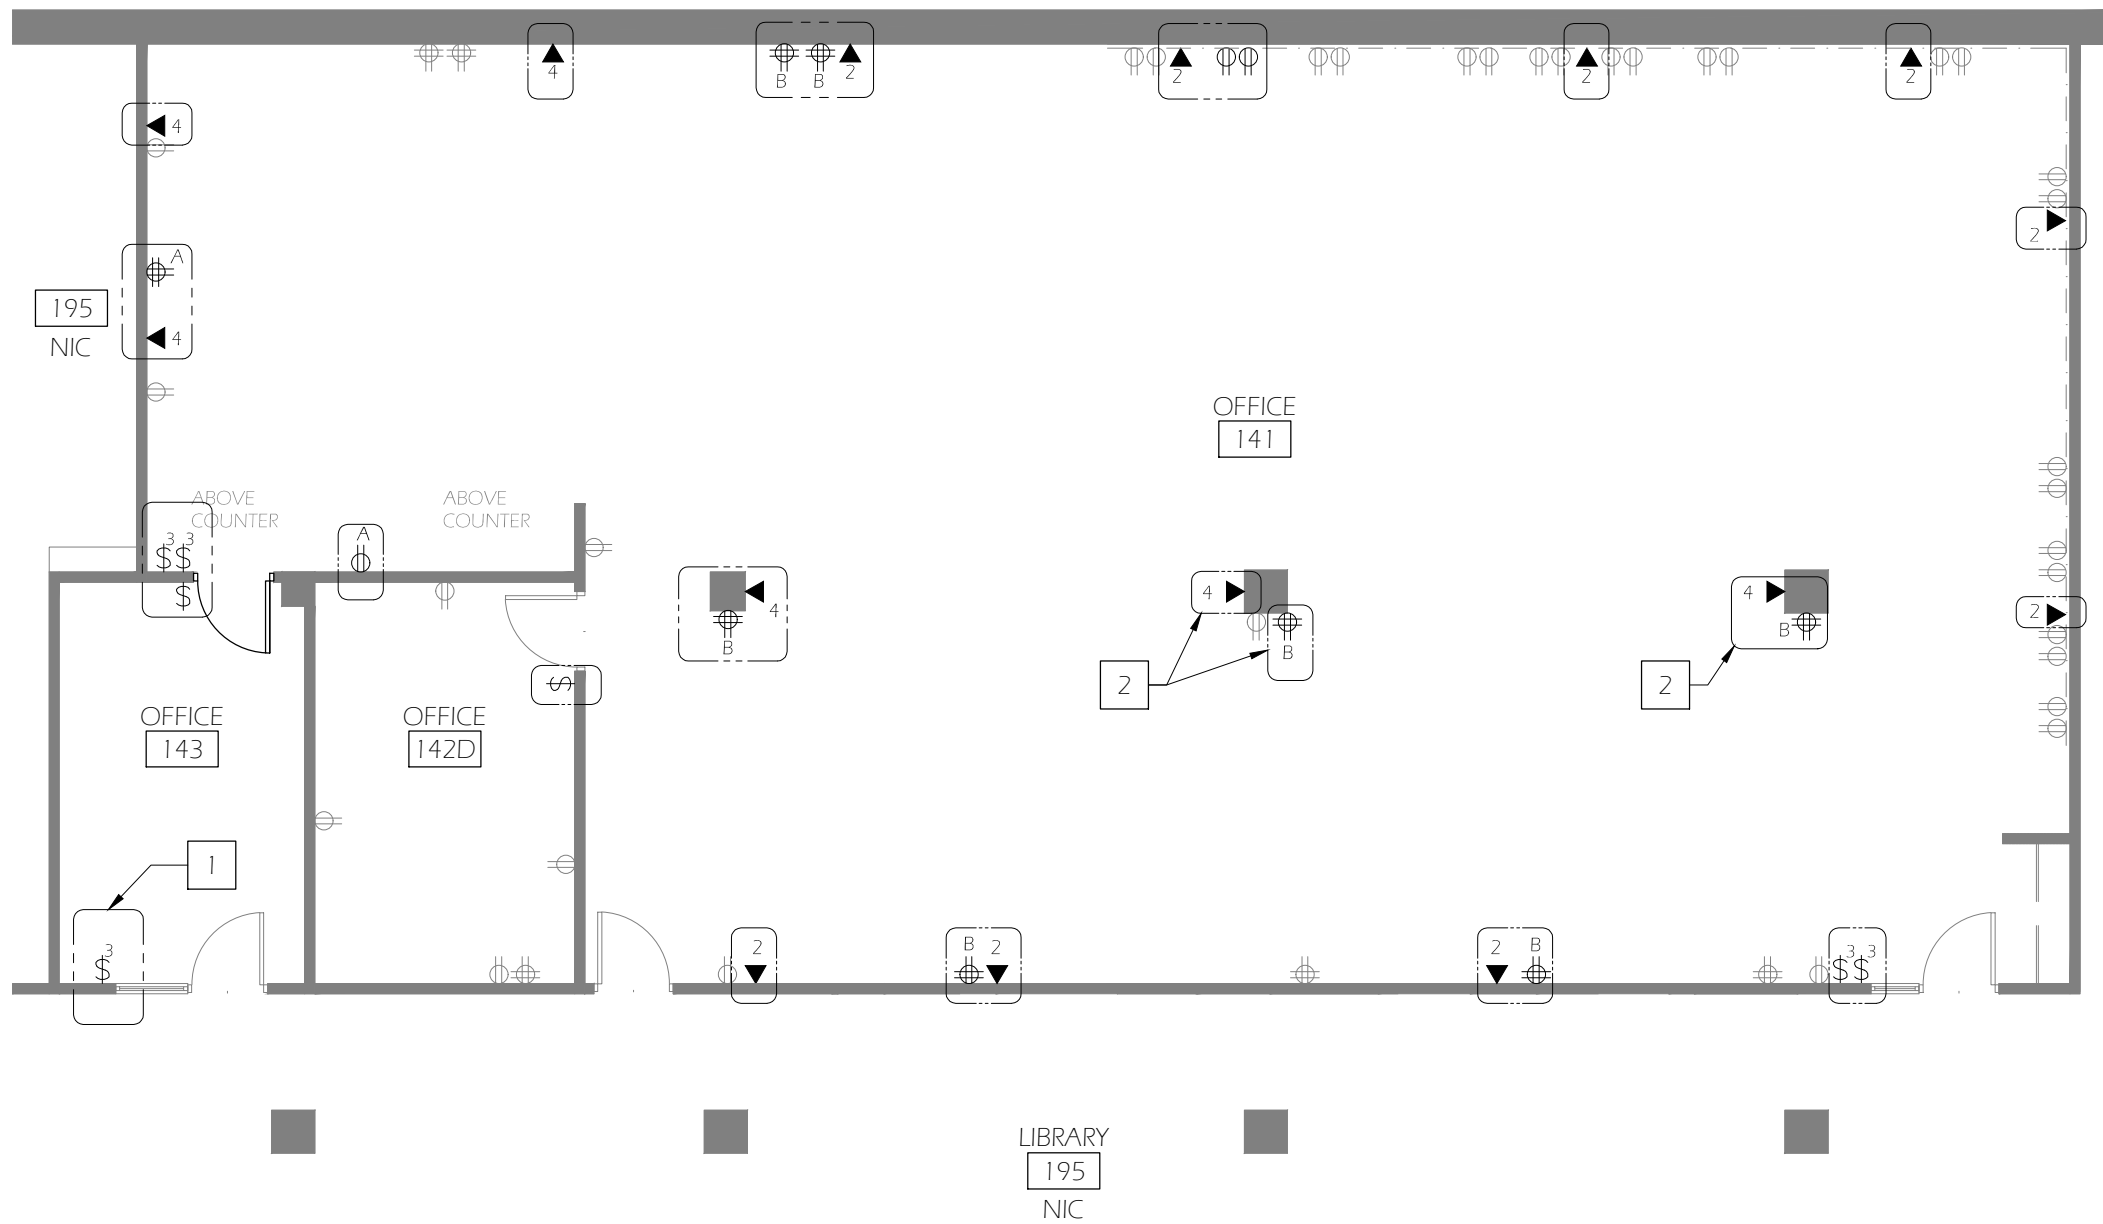
DESIGN/DRAWN BY:
KS/MNL

SCALE:
AS NOTED

DRAWING NO.:
E003

1
E003 **DEMOLITION ELECTRICAL REFLECTED CEILING PLAN - ALTERNATE 1**
Scale: 1/8" = 1'-0"



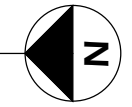

GENERAL NOTES

1. PROTECT & PRESERVE ADJACENT (E) FINISHES TO REMAIN FROM DAMAGE CAUSED BY DEMOLITION & CONSTRUCTION. CONTRACTOR TO REPAIR INCIDENTAL DAMAGE AT OWN EXPENSE
2. NETWORK SERVICES WILL PROVIDE AND INSTALL DATA CABLING; BIDS TO INCLUDE PATHWAYS ONLY.
3. CONTRACTOR TO VERIFY PANEL CAPACITY AND CIRCUITS
4. COMPLY WITH NEC AND DIVISION 26 OF THE UNIVERSITY CONSTRUCTION STANDARDS
5. ALL DATA CONDUIT TO BE 3/4" EMT, NO FLEXIBLE CONDUIT

KEYED NOTES

- 1 NEW SWITCH IN EXISTING BOX
- 2 SURFACE MOUNT ON EXISTING COLUMNS

LEGEND

- ◻ INDICATES FIXTURE TO BE ADDED; LIGHT SWITCH, OUTLET, DATA & THERMOSTAT
- EXISTING 4000 SERIES WIREMOLD TO REMAIN
- ▶ NEW DATA RECEPTACLE
- ⊖ 120 VOLT DUPLEX RECEPTACLE OUTLET MOUNTED AT STANDARD HEIGHT
- ⊕ 120 VOLT QUAD RECEPTACLE OUTLET MOUNTED AT STANDARD HEIGHT

General Notes		
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No.	Revision/Issue	Date



NEW WORK ELEC. PLAN

UNIVERSITY OF OREGON

DESIGN SERVICES GROUP
1295 FRANKLIN BOULEVARD
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(541) 346-2270

PROJECT NAME:
KNIGHT LIBRARY
1ST FLOOR
THE DIGITAL
SCHOLARSHIP CTR

PROJECT NO.:
WK224612


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06/12/2013


DESIGN/DRAWN BY:
KS/MNL

SCALE:
AS NOTED

DRAWING NO.:
E101

1 **NEW WORK ELECTRICAL FLOOR PLAN**
E101 Scale: 1/8" = 1'-0"

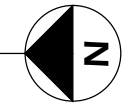

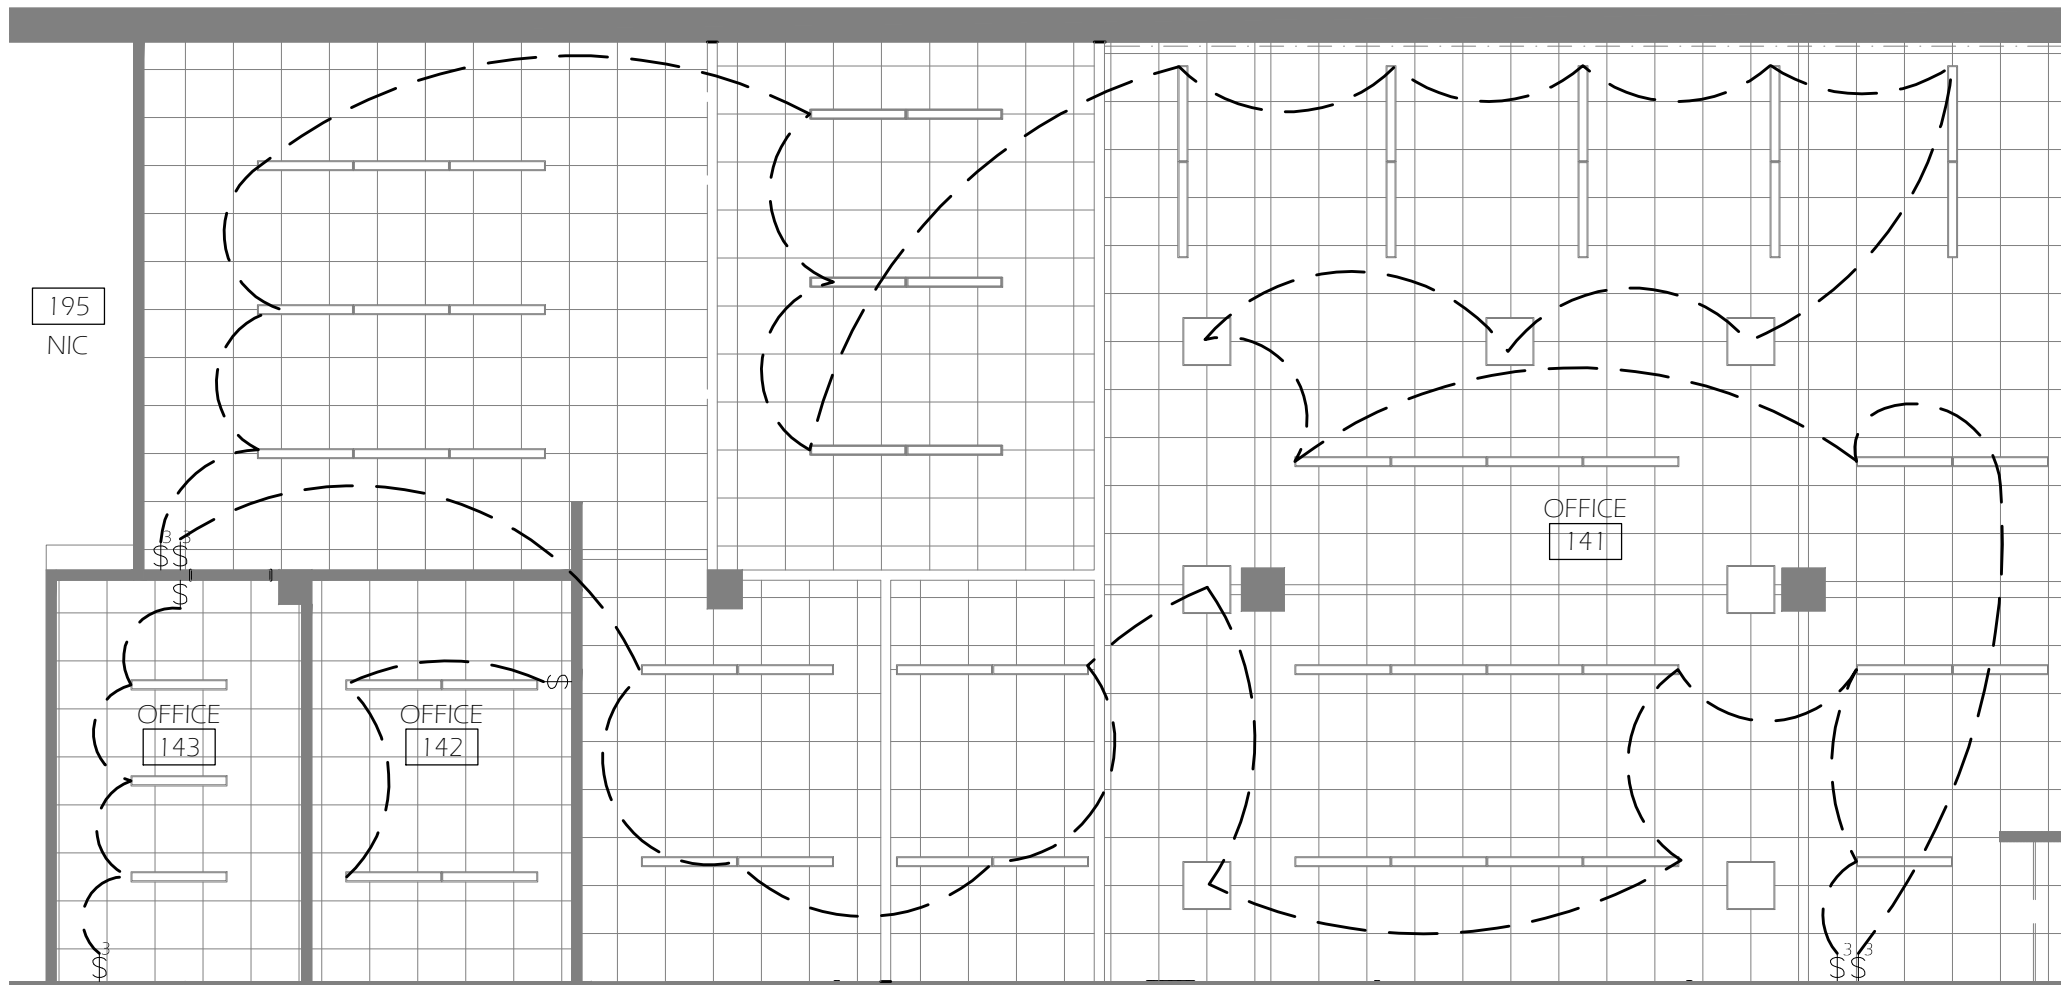

GENERAL NOTES

- PROTECT & PRESERVE ADJACENT (E) FINISHES TO REMAIN FROM DAMAGE CAUSED BY DEMOLITION & CONSTRUCTION. CONTRACTOR TO REPAIR INCIDENTAL DAMAGE AT OWN EXPENSE


KEYED NOTES

1 XX

LEGEND

- - - INDICATES WIRING BETWEEN EXISTING SWITCH AND LIGHTING TO BE RE-ROUTED

General Notes		
△	XXX	xx/xx/13
No.	Revision/Issue	Date

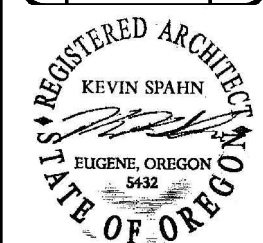

NEW WORK ELEC. PLAN

DRAWING TITLE: UNIVERSITY OF OREGON

FACILITIES SERVICES
1276 UNIVERSITY OF OREGON
EUGENE, OREGON 97403-1276

DESIGN SERVICES GROUP
1295 FRANKLIN BOULEVARD
EUGENE, OREGON 97401-3430

PROJECT NAME:
KNIGHT LIBRARY
1ST FLOOR
THE DIGITAL
SCHOLARSHIP CTR

PROJECT NO.:
WK224612


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06/12/2013


DESIGN/DRAWN BY:
KS/MNL

SCALE:
AS NOTED

DRAWING NO.:
E102

1 NEW WORK ELECTRICAL REFLECTED CEILING PLAN - ALTERNATE 1
E102 Scale: 1/8" = 1'-0"

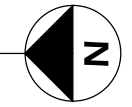

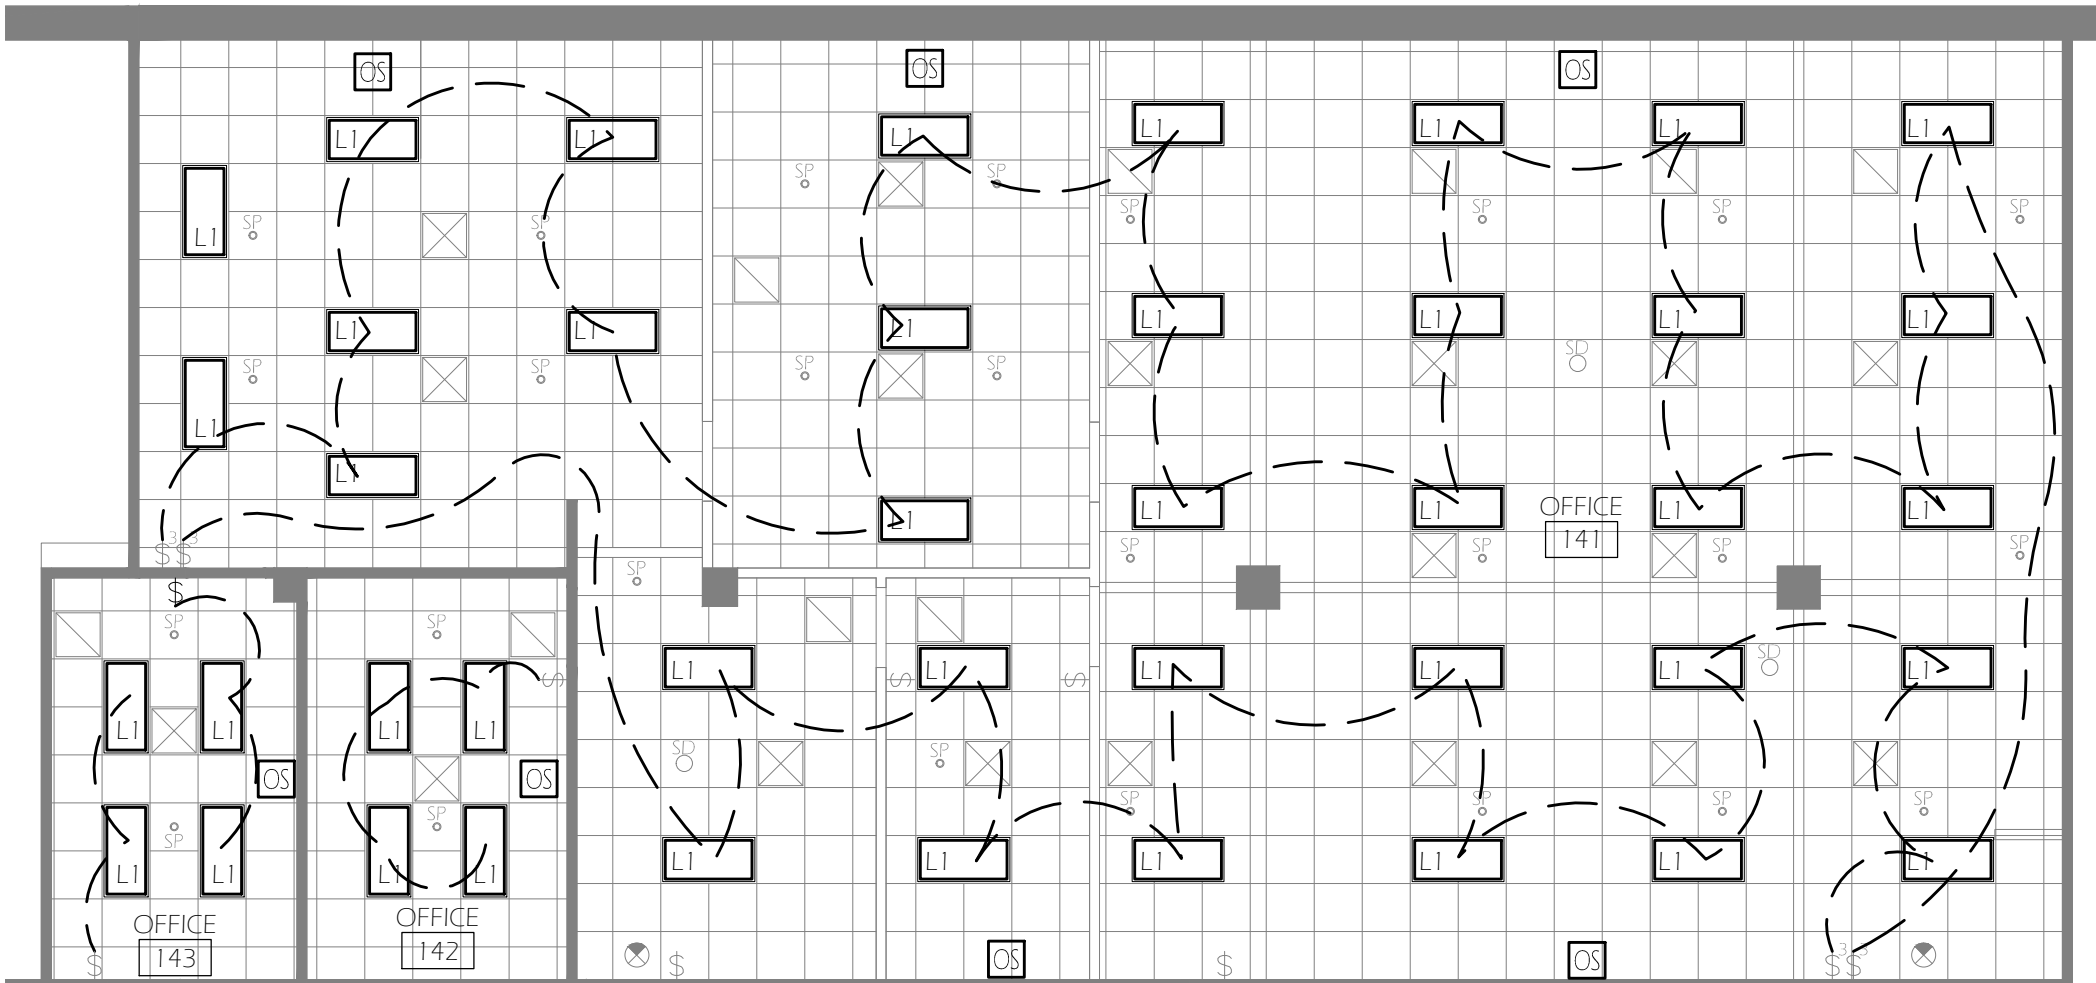

GENERAL NOTES

- PROTECT & PRESERVE ADJACENT (E) FINISHES TO REMAIN FROM DAMAGE CAUSED BY DEMOLITION & CONSTRUCTION. CONTRACTOR TO REPAIR INCIDENTAL DAMAGE AT OWN EXPENSE

KEYED NOTES

[1] XX


LEGEND

LI NEW LIGHT, AVANTE 4' FIXTURE, UPLIGHT, T-8 OSPSX BALLAST, METAL DIFFUSED ROUND HOLE, LITHONIA #AVSM-2-32-MDR-URL-MVOLT-OSPSX

X EXIT LIGHT

OS "WATTSTOPPER" 120V POWER PACK CAT #B-120E-P & OCC SENSOR, "WATTSTOPPER" DT 200 OR CX-100

NOTE: CONTRACTOR TO FIELD VERIFY EGRESS LIGHTING LEVELS MEET CODE REQUIREMENTS

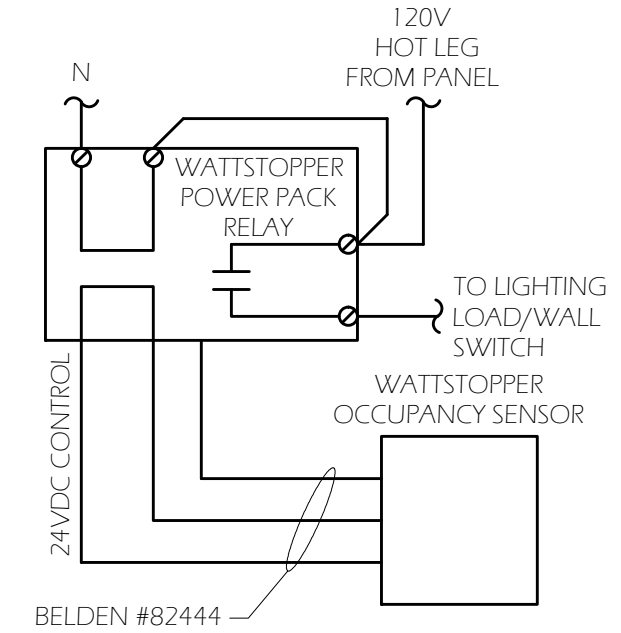

General Notes		
△	XXX	xx/xx/13
No.	Revision/Issue	Date



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DESIGN SERVICES GROUP
1295 FRANKLIN BOULEVARD
EUGENE, OREGON 97403-1270
(541) 346-2270

DESIGN SERVICES
1276 UNIVERSITY OF OREGON
EUGENE, OREGON 97403-1276

DRAWING TITLE: **DEMO ELECTRICAL PLAN**

PROJECT NAME:
KNIGHT LIBRARY
1ST FLOOR
THE DIGITAL
SCHOLARSHIP CTR

PROJECT NO.:
WK224612

DATE:
06/12/2013


DESIGN/DRAWN BY:
KS/MNL


SCALE:
AS NOTED

DRAWING NO.:

E103

1 NEW WORK ELECTRICAL REFLECTED CEILING PLAN - ALTERNATE 1
E103 Scale: 1/8" = 1'-0"

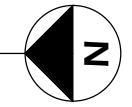

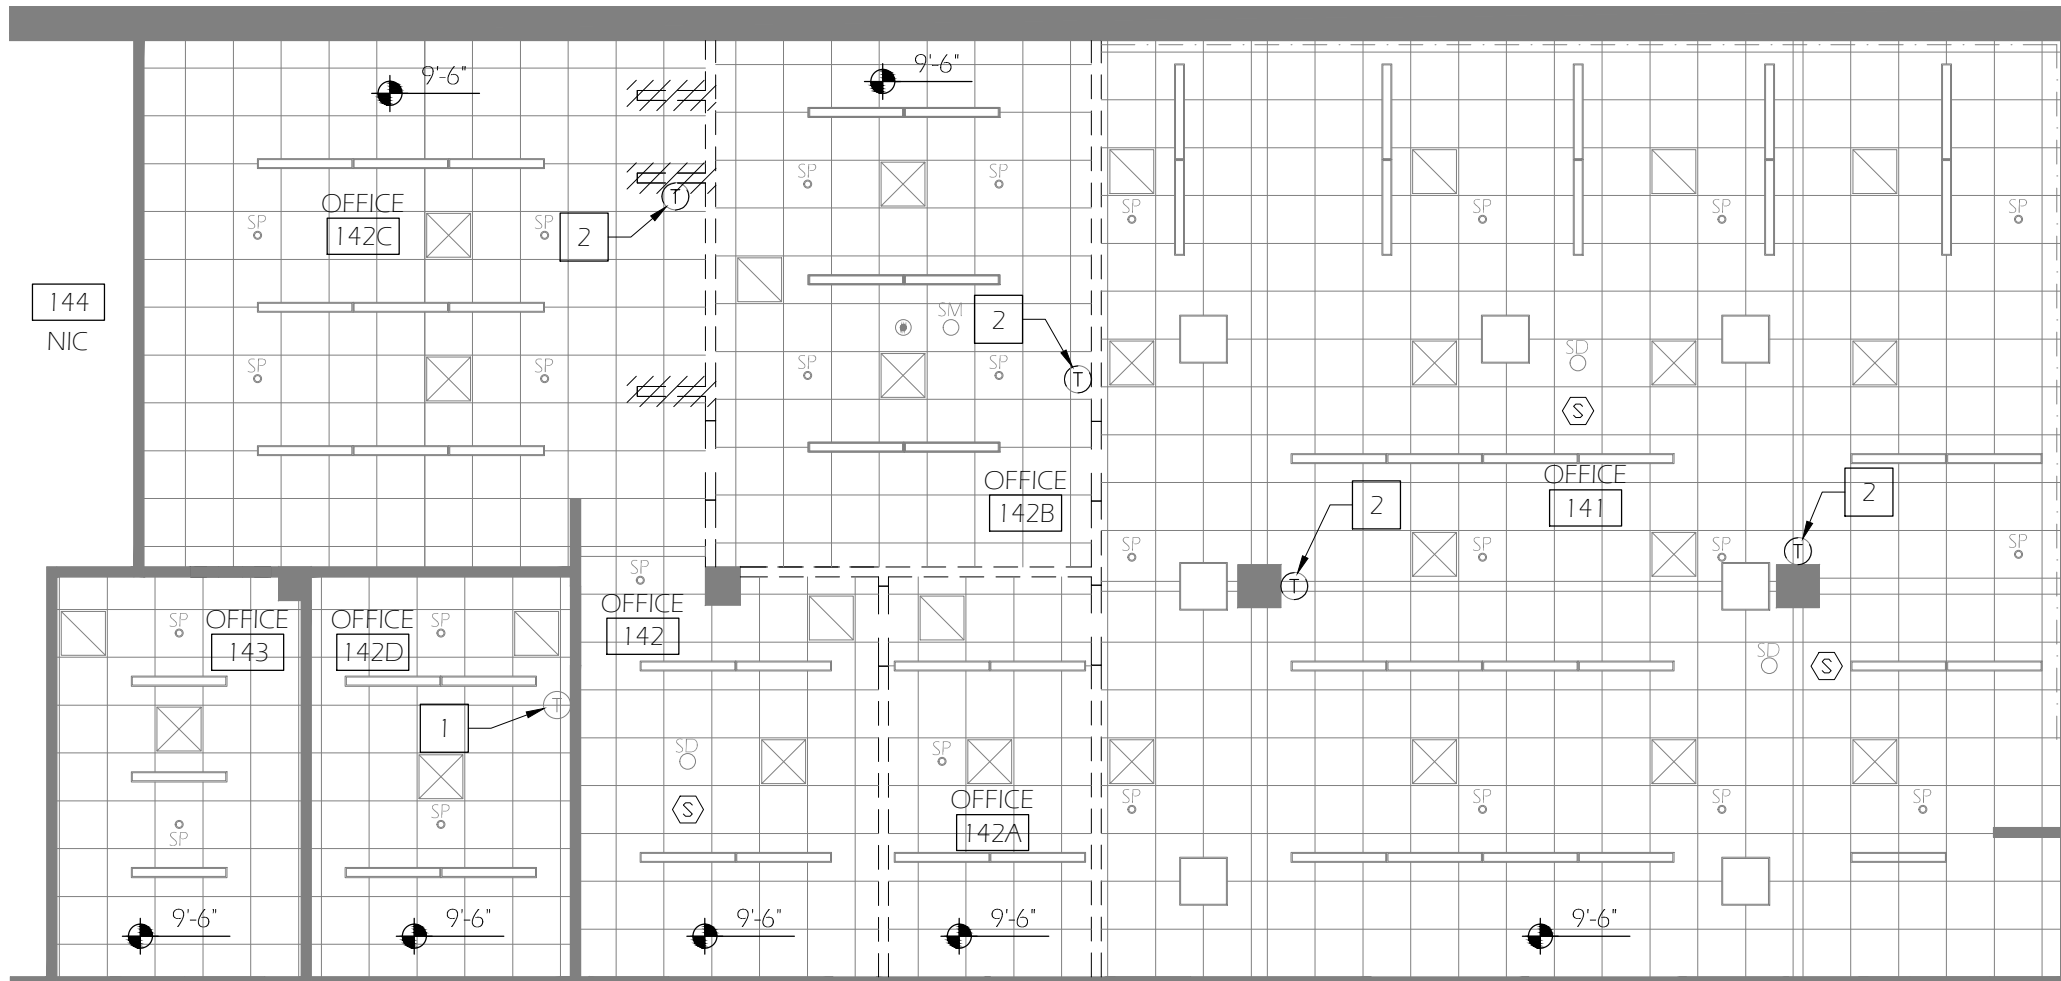

GENERAL NOTES

1. REFER TO ARCHITECTURAL DRAWINGS FOR DEMOLITION REQUIREMENTS WHERE WALLS ARE TO BE REMOVED
2. THE MECHANICAL CONTRACTOR WILL BE REQUIRED TO FIELD VERIFY THE EXACT LOCATION AND IDENTIFICATION OF EACH SERVICE PRIOR TO STARTING DEMOLITION OR NEW WORK IN AREAS UNDER THIS SCOPE OF WORK

DEMO PLAN KEYED NOTES

- 1 EXISTING THERMOSTAT TO REMAIN
- 2 REMOVE EXISTING THERMOSTAT

LEGEND

- EXISTING SUPPLY TO REMAIN
- EXISTING RETURN TO REMAIN

General Notes		
No.	Revision/Issue	Date



DESIGN SERVICES GROUP
 1295 FRANKLIN BOULEVARD
 EUGENE, OREGON 97403-12176
 (541) 346-2270

UNIVERSITY OF OREGON
 FACILITIES SERVICES
 1276 UNIVERSITY OF OREGON
 EUGENE, OREGON 97403-12176

DEMOLITION MECHANICAL

PROJECT NAME:
 KNIGHT LIBRARY
 1ST FLOOR
 THE DIGITAL
 SCHOLARSHIP CTR

PROJECT NO.:
 WK224612

DATE:
 06/12/2013

DESIGN/DRAWN BY:
 KS/MNL

SCALE:
 AS NOTED

DRAWING NO.:

M001

