CONTRACT

DOCUMENTS

DESIGN GROUP

PROPERTY OWNER

THE STATE OF OREGON, ACTING BY AND THROUGH THE STATE BOARD OF HIGHER EDUCATION ON BEHALF OF UNIVERSITY OF OREGON

CONTACT: FACILITIES SERVICES, DEPARTMENT OF CAPITAL CONSTRUCTION

1276 UNIVERSITY OF OREGON EUGENE, OR 97403-1276

ARCHITECTURAL

WESTERN ARCHITECTURAL

Contact: JAMES HAGERMAN, ARCHITECT
10200 SW Greenburg Rd. #750

Portland, OR 97223

(503) 297-0665 FAX (503) 297-0757 E-Mail: jamesh@westernarchitectural.com

CIVIL ENGINEER N/A

LANDSCAPE N/A

PLUMBING ENGINEER

N/A

STRUCTURAL ENGINEER

WESTERN ARCHITECTURAL

Contact: ED CRABAUGH, ENGINEER

10200 SW GREENBURG ROAD SUITE 150

PORTLAND, OREGON 97223

(503) 297-0665 FAX (503) 297-0757 E-Mail: edc@westernarhitectural.com

PROJECT DATA

PROJECT STATISTICS

EDUCATION FACILITY	CLASSROOM
SINGLE UNIT AREA	NO CHANGE
TOTAL HABITABLE AREA	NO CHANGE
NUMBER OF BUILDINGS	1

BUILDING CODE SUMMARY

OCCUPANCY CLASSIFICATION	В
CONSTRUCTION TYPE	Type II A
NUMBER OF STORIES	3
SEISMIC ZONE	3
AREA SEPARATION WALLS	NO CHANGE
SMOKE DETECTORS	NO CHANGE
ENERGY COMPLIANCE	NO CHANGE

CODES:

2010 OREGON STRUCTURAL SPECIALTY CODE for work under this contract.

Current NATIONAL ELECTRICAL CODE with state and local amendments.

AMERICAN WITH DISABILITIES ACT applicable to common use facilities.

Current STATE OF OREGON MECHANICAL SPECIALTY CODE.

Current UNIFORM FIRECODE with state and local amendments.

Current STATE OF OREGON PLUMBING SPECIALTY CODE with state and local amendments.

Area separation wall no changes internally.

Comply with current codes and regulations of WASHINGTON COUNTY.

SITE DATA

BUILDING AREA:

BULDING AREA:	NO CHANGE
IMPERVIOUS SURFACE: Paving, Sidewalk, Patio	NO CHANGE
LANDSCAPING	NO CHANGE
TOTAL LOT AREA	NO CHANGE

PROJECT ZONING

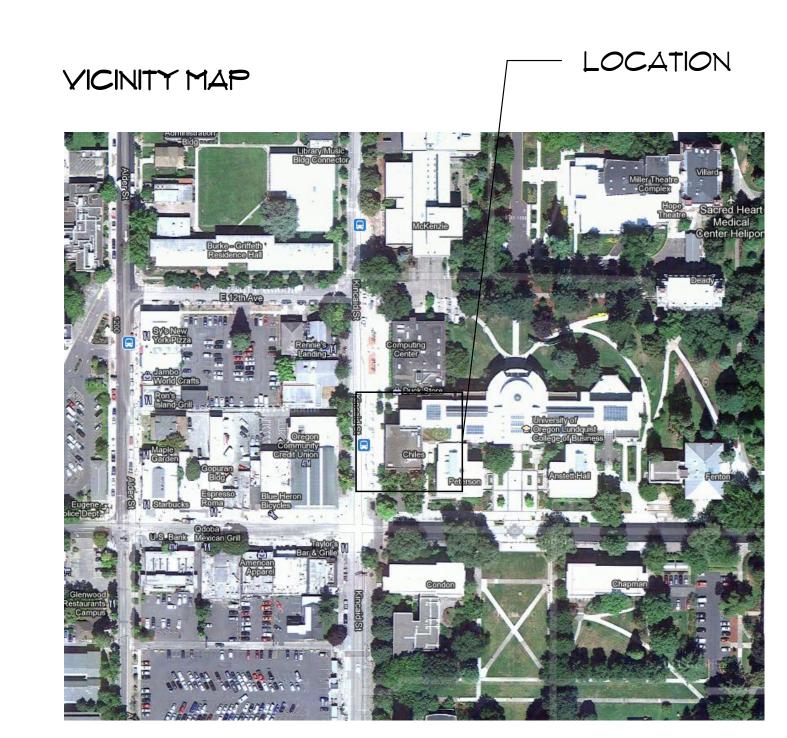
JURISDICTION	LANE COUNTY
LAND USE DISTRICT	NO CHANGE
EXISTING USE	CLASSROOM
PROPOSED USE	NO CHANGE
REVIEW APPLICATION TYPE	TYPE I COMPLIANCE LETTER

BUILDING SETBACKS

FRONT	NO CHANGE
BETWEEN UNITS	NO CHANGE
SIDE YARD	NO CHANGE
REAR YARD	NO CHANGE
MAX. BUILDING HEIGHT	NO CHANGE

DRAWING INDEX

ARCHITECTURAL



FOR BID PURPOSES ONLY.
NOT FOR CONSTRUCTION



% Salt Lake City Utah Las Vegas, Nevada 2-0757

WESTERN/ARCHITECTURAL forens/c architects 6 angineers
10200 SW Greenburg Road, #750
Portland, Oregon 97223

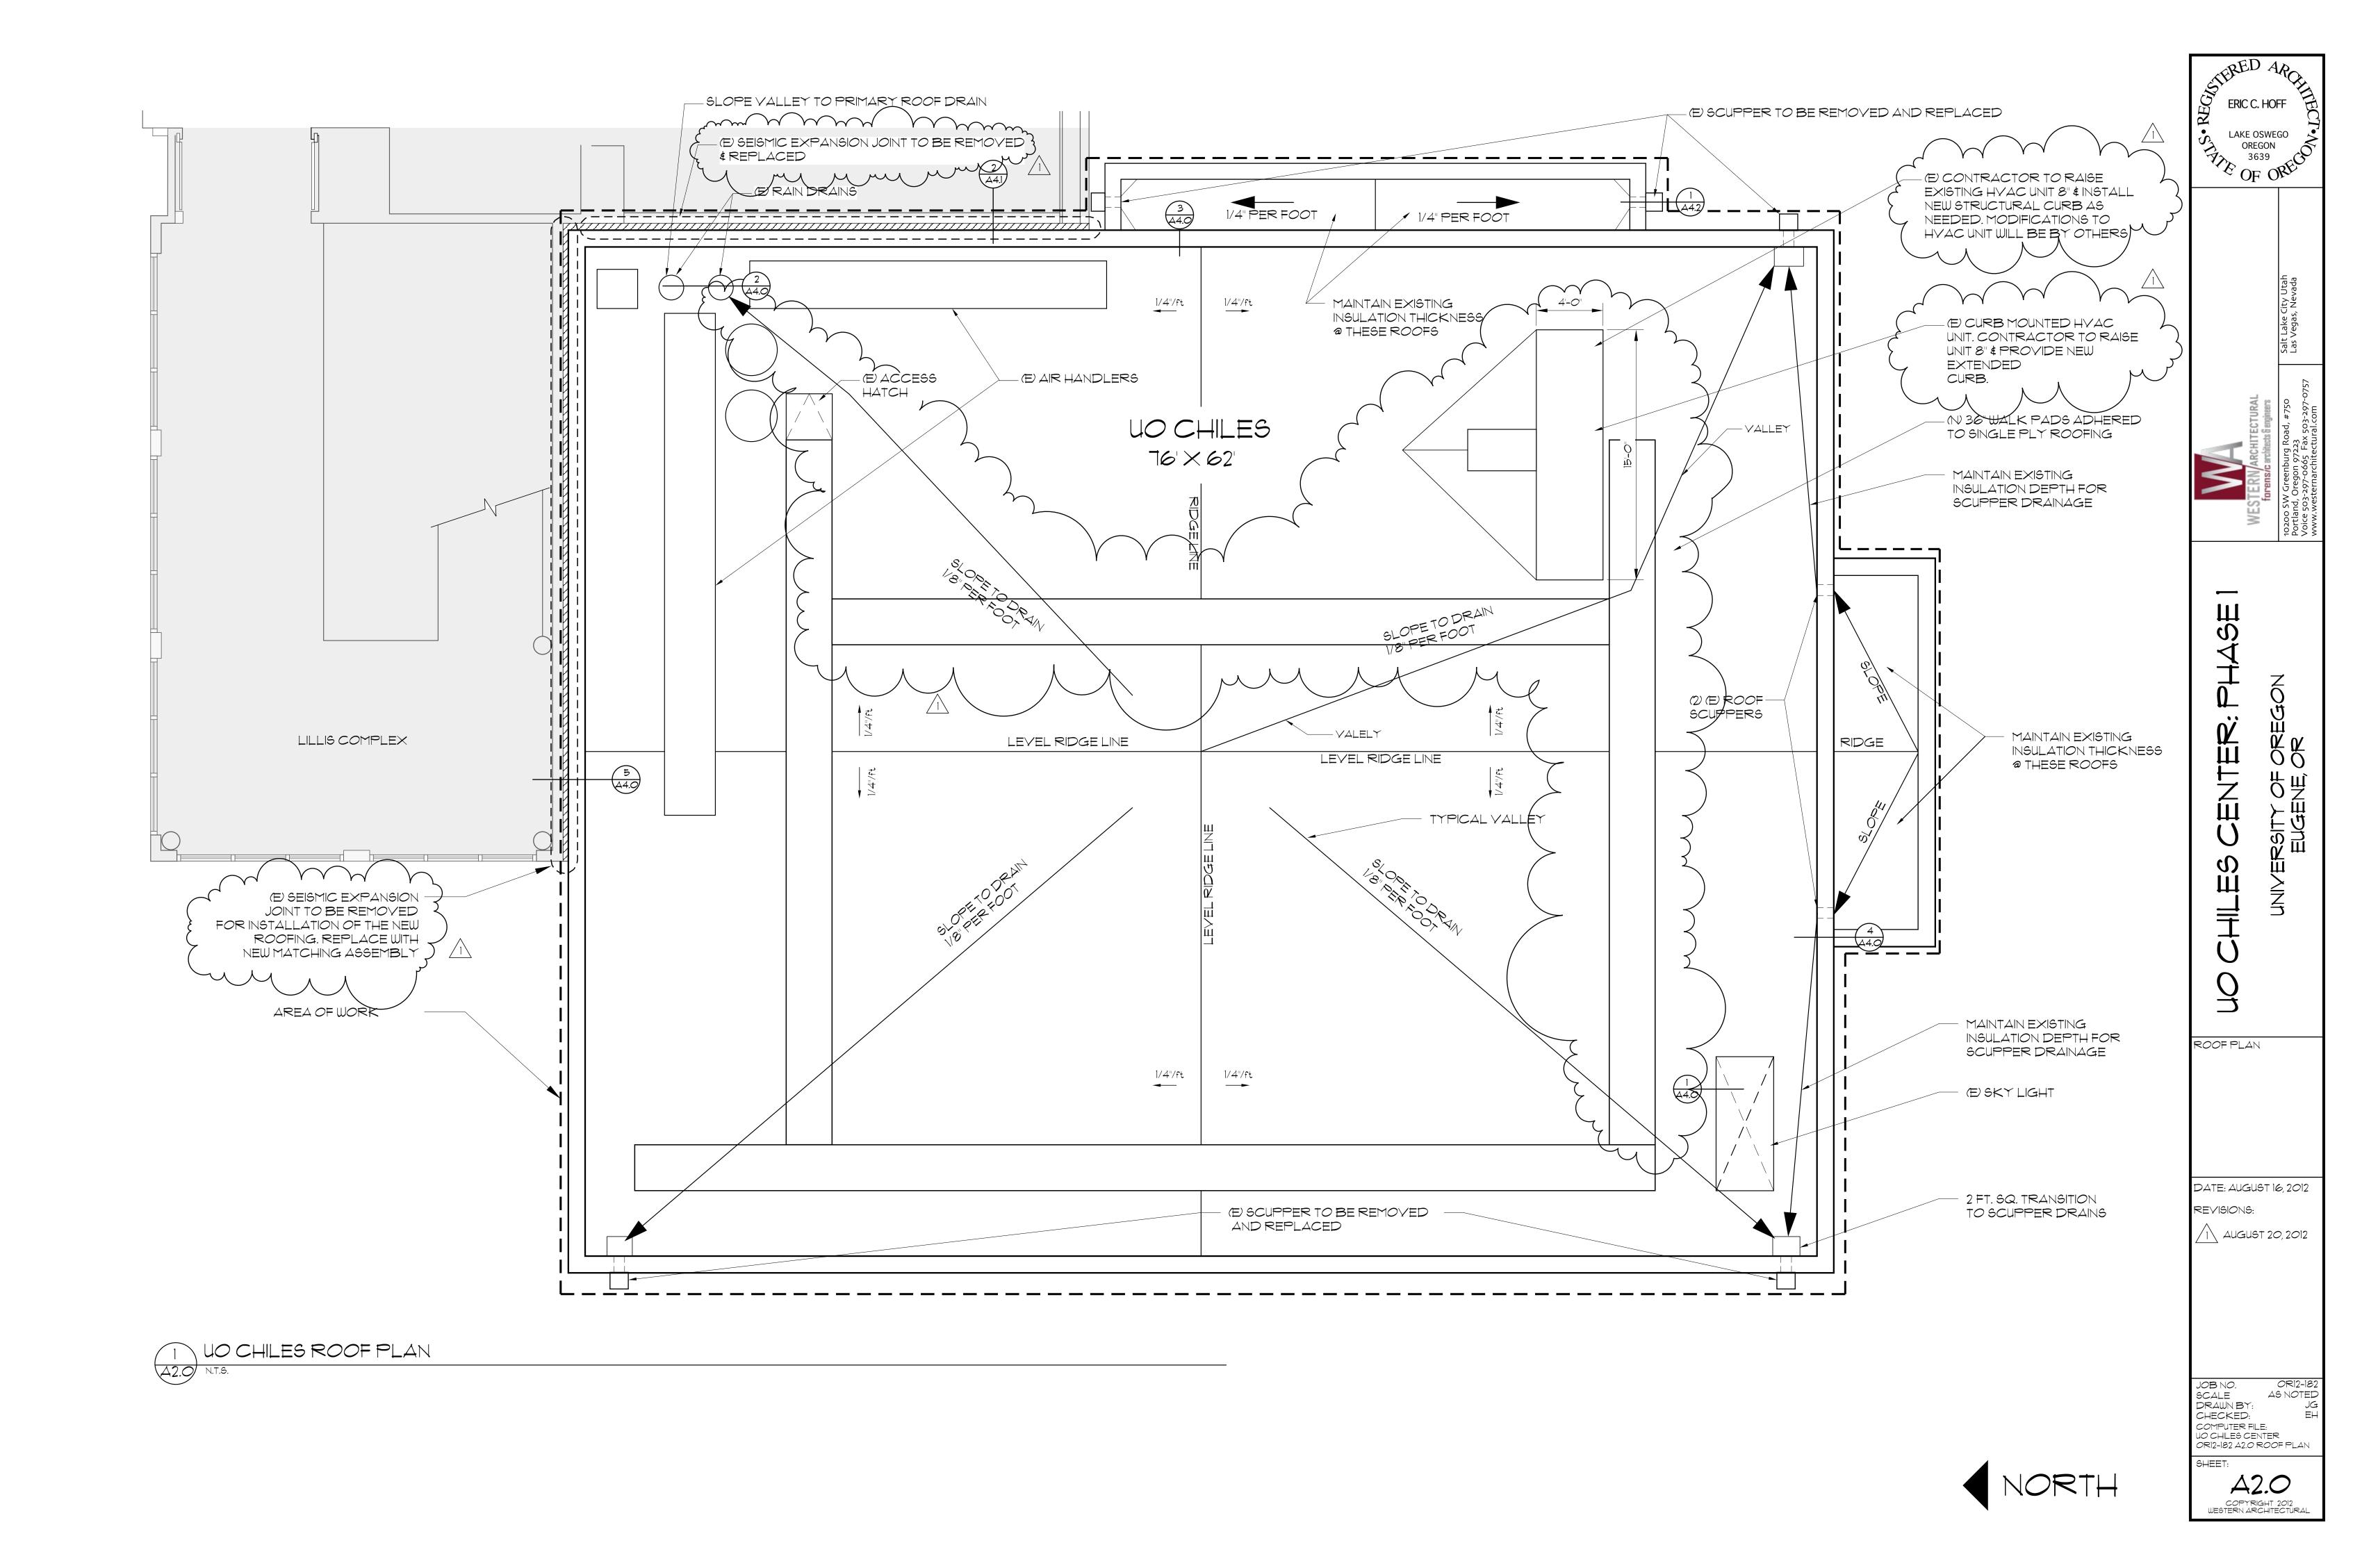
CODE SUMMARY, SITE DATA, ZONING, DRAWINGS LIST, VICINITY MAP

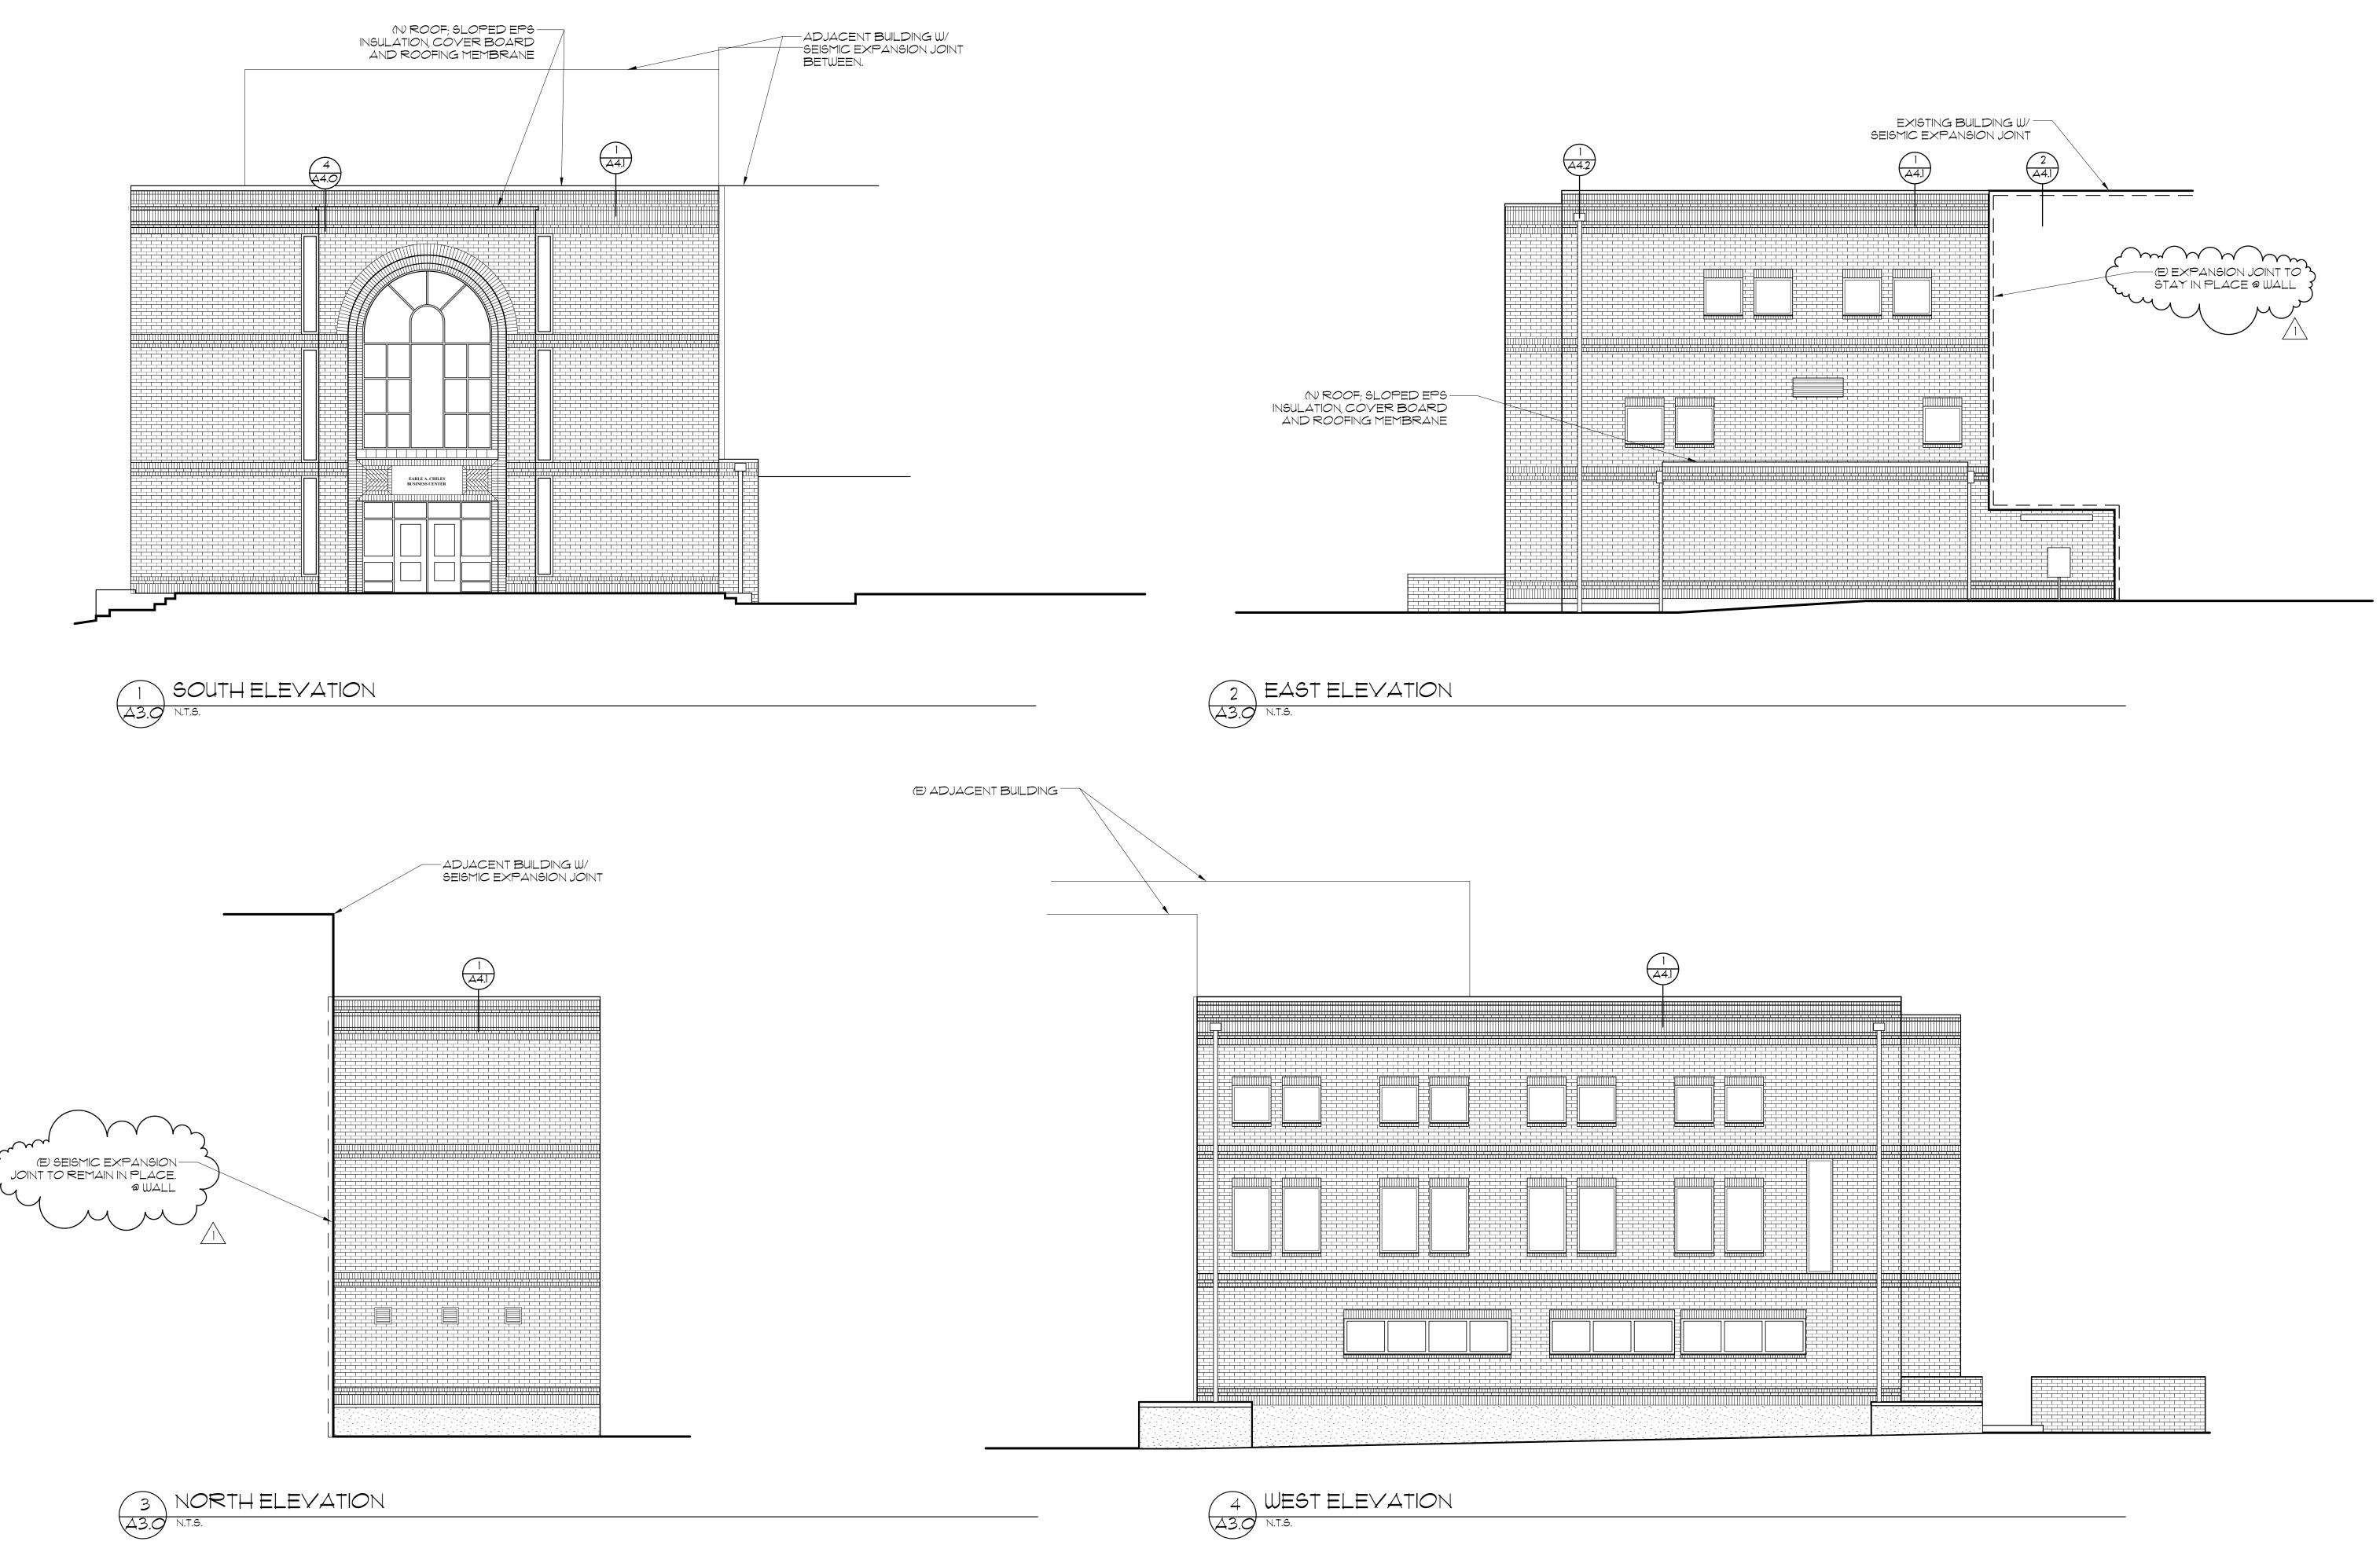
DATE: AUGUST 16, 2012

REVISIONS:

JOB NO. OR12-182
SCALE AS NOTED
DRAWN BY: JG:
CHECKED: EH
COMPUTER FILE:
UO CHILES CENTER
OR12-182 A1.0 COVER PAGE
SHEET:

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Voice 503-297-0665 Fax 503-297-0757

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ELEVATIONS

REVISIONS:

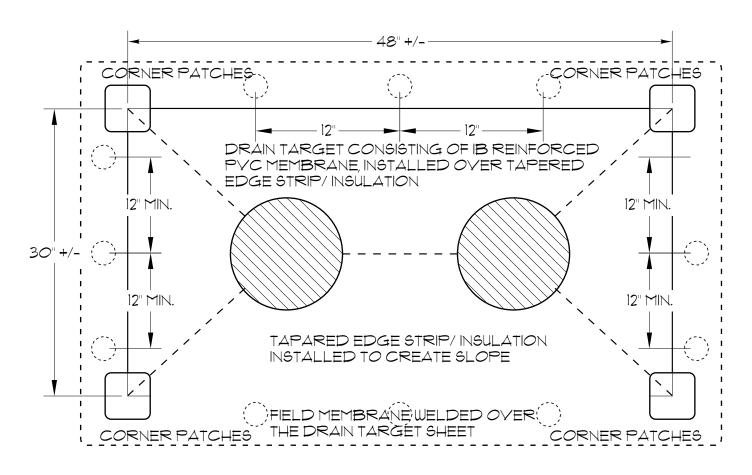
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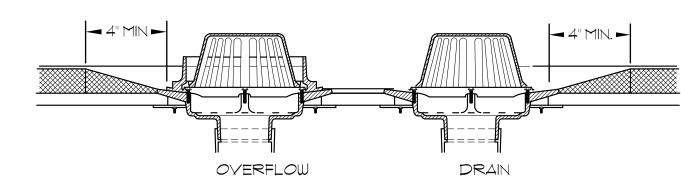
AUGUST 20, 2012

JOB NO. OR12-182
SCALE AS NOTED
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OR12-182 A3.0 ROOF PLAN

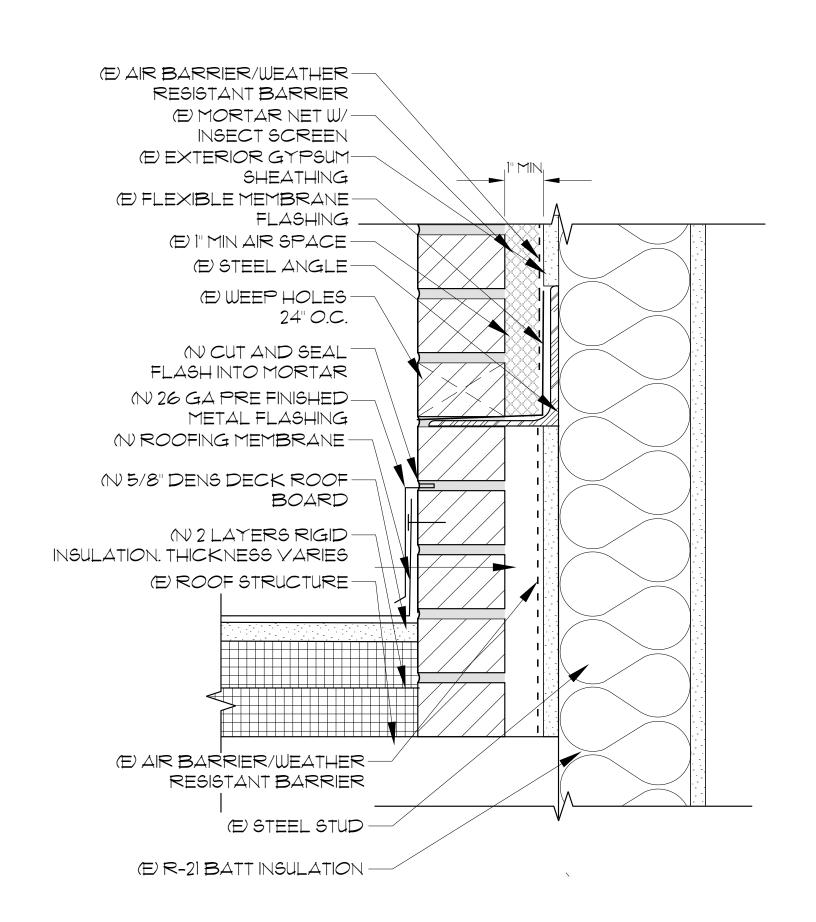
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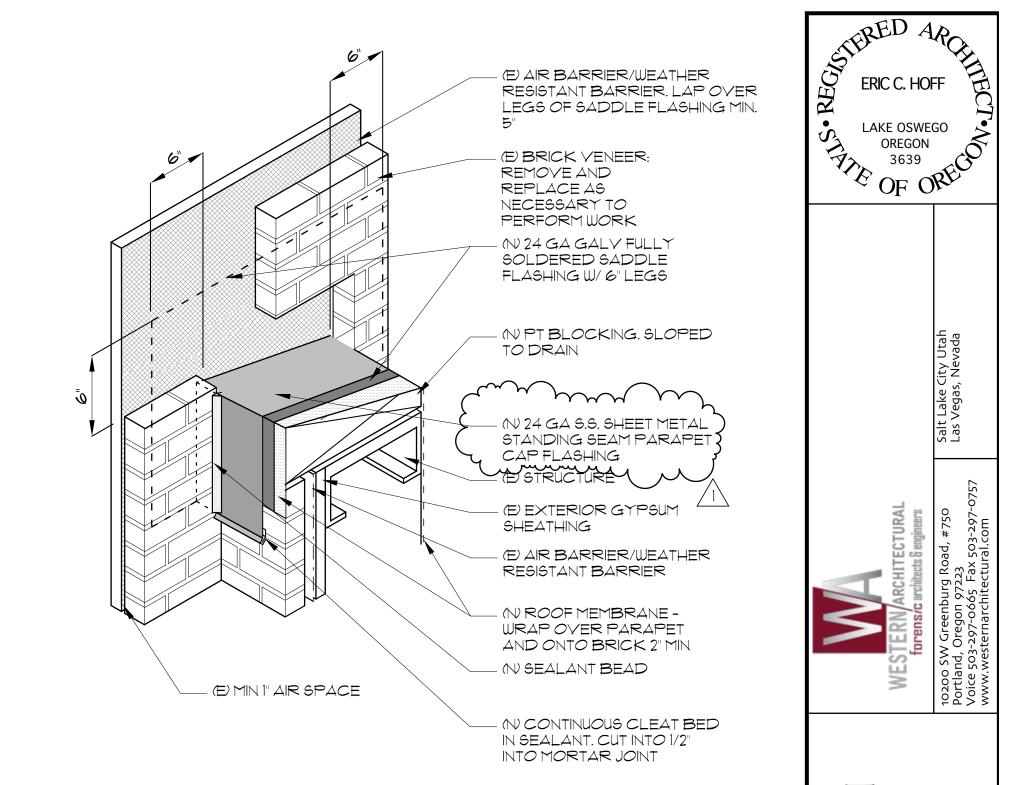
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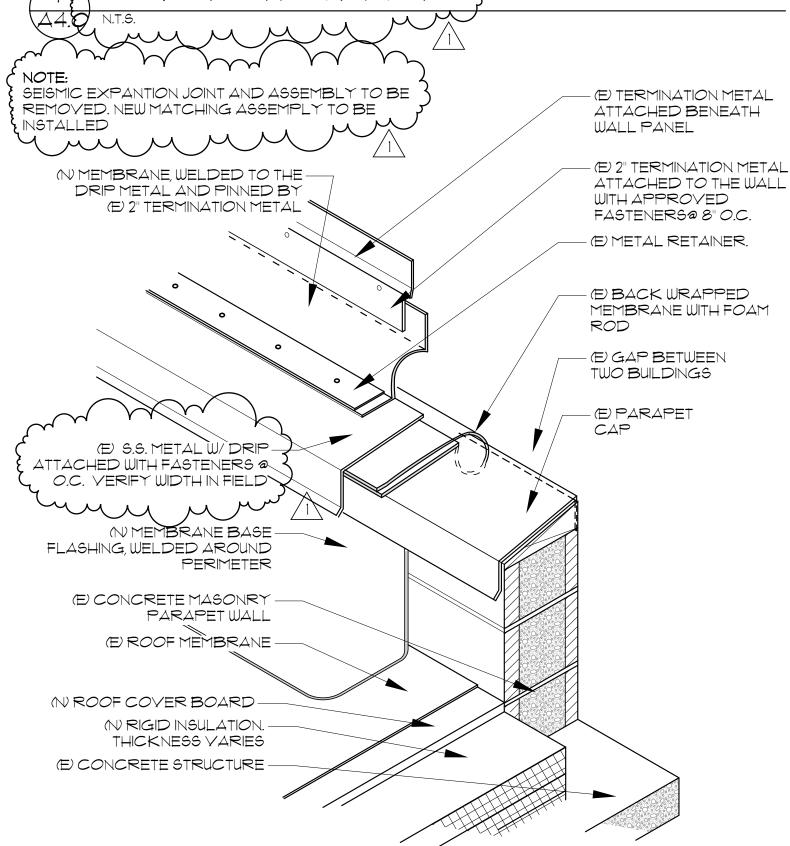


- NOTES: THIS DETAIL IS GENERIC IN NATURE AND SHOWS A TAPERED SUMP CREATED BY INSULATION. RE-ROOF AND RE-COVER INSTALLATIONS: ENSRE THAT NO ASPHALTIC RESIDUE(I.E. PLASTIC ROOF CEMENT, STEEP SLOPE ROOFING ASPHALT, WET PATCH, ETC) COMES IN
- DIRECT CONTACT WITH THE PVC MEMBRANE. RIGID ROOF INSULATION CAN BE SHAVED TO FORM A ROUND TAPERED SUMP FOR BETTER WATER-FLOW TO THE RAIN RECEPTACLE.
- ALL OTHER, NON-CLAMPING STYLE ROOF DRAINS AND OVERFLOWS MUST BE PRE-APPROVED BY IB ROOF SYSTEMS BEFORE INSTALLATION.





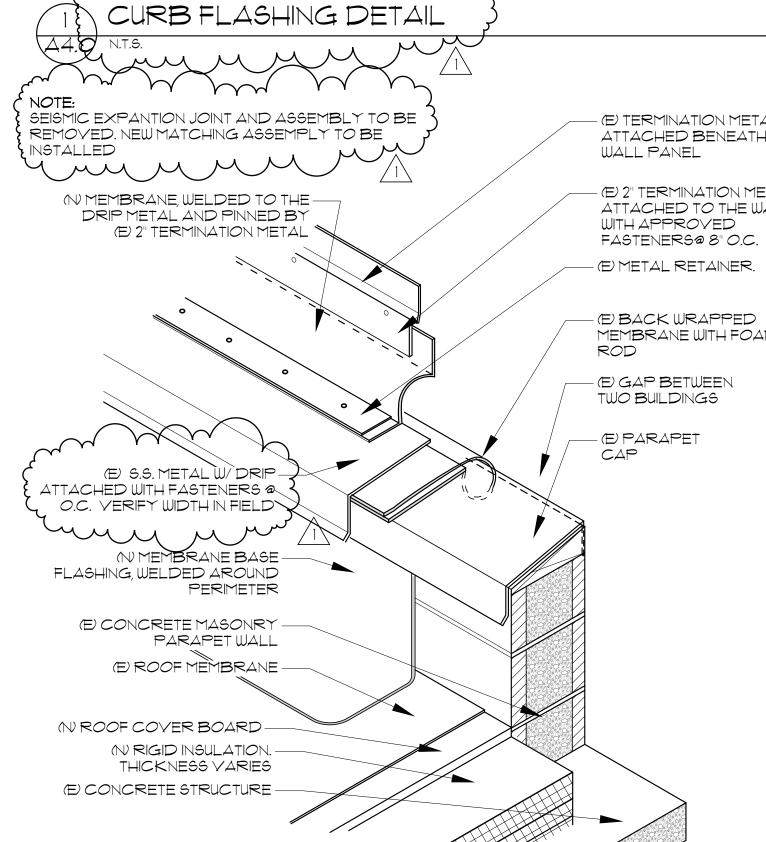




DRAIN DETAIL

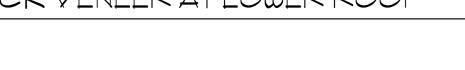
BRICK YENEER AT LOWER ROOF

BRICK YENEER AT SADDLE FLASHING



EXPANSION/SEISMIC DETAIL AT PARAPET TO WALL

•ALL DETAILS ARE DRAWN EXAGGERATED AND EXPLODED TO SHOW LAYER ORDER; MATERIALS SHOULD MEET SURFACES OUTLINED IN THE SCOPE OF WORK.





LAKE OSWEGO

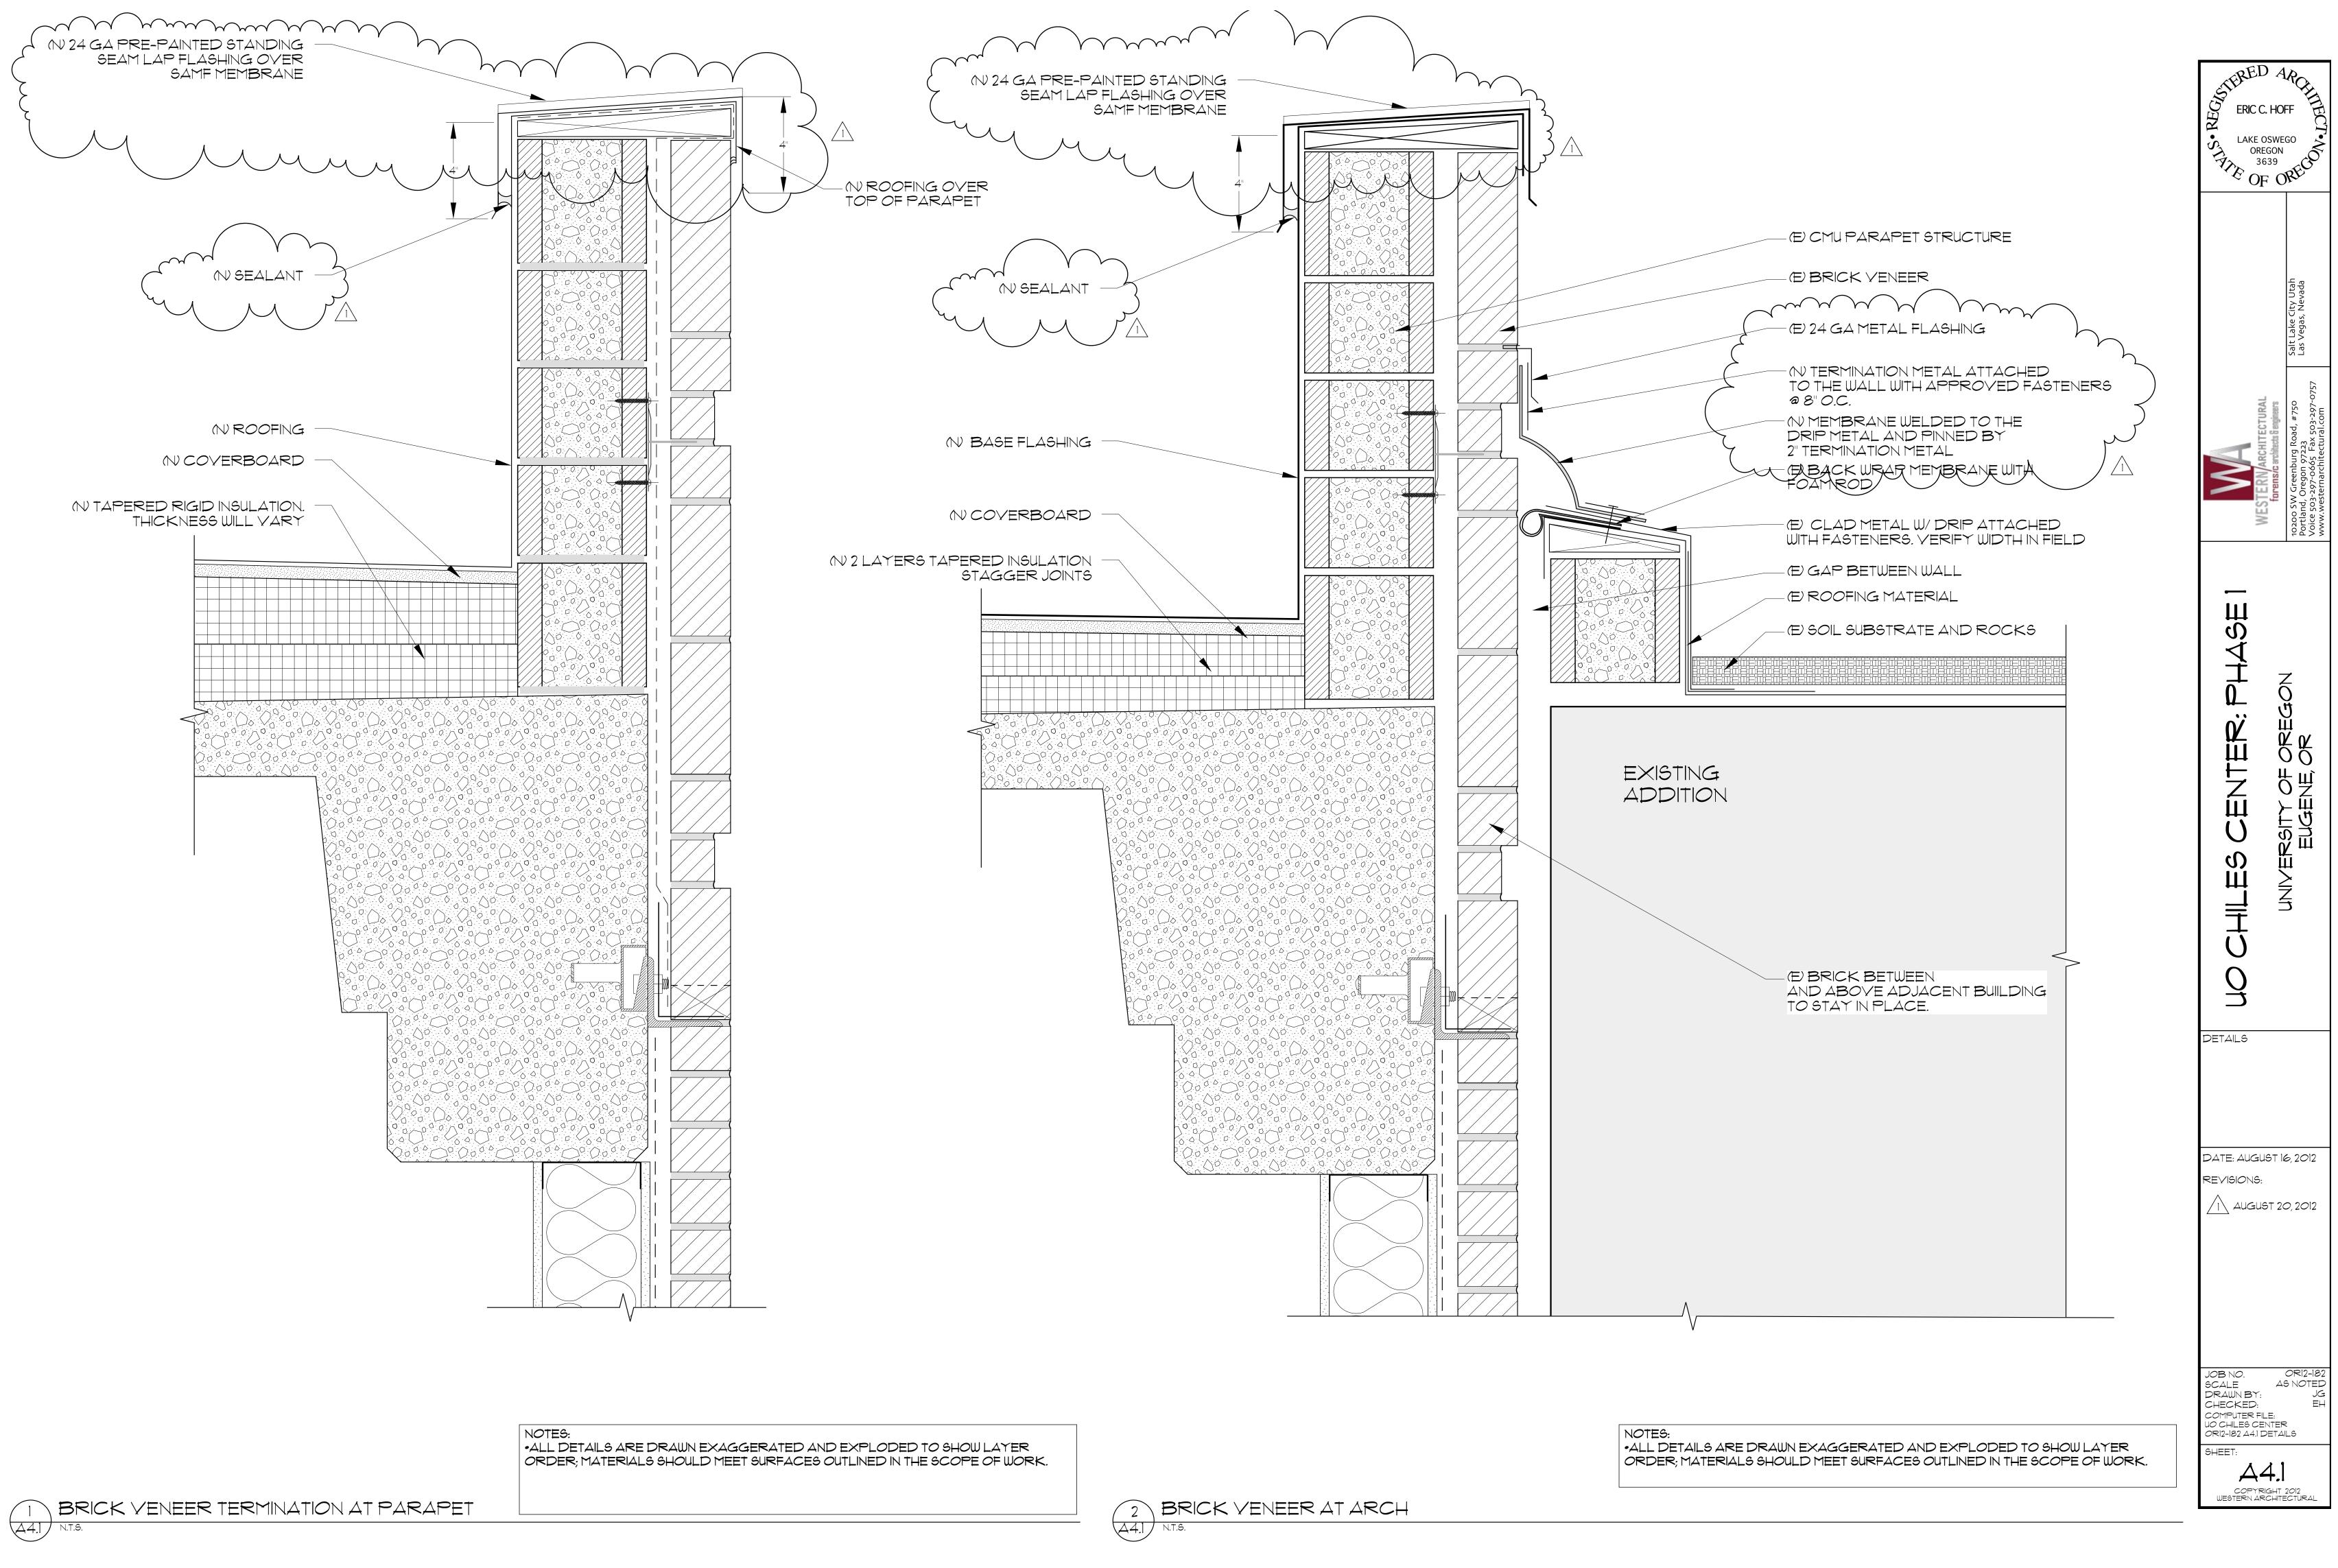
DETAILS

DATE: AUGUST 16, 2012 REVISIONS:

AUGUST 20, 2012

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